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PROJECT TEAM:

YARDARM GROUP OWNER/DEVELOPER

2440 W COMMODORE WAY

TRANSPARENCY AREA = 580 SQFT (26.3%)

(FACADE SQFT VERIFIED USING AUTOCAD AREA

SUITE 200

SEATTLE, WA 98199

(206) 2|6-0220

ARCHITECT NASH AND ASSOCIATES ARCHITECTS

> 8003 | 18TH AVE NE KIRKLAND, WA 98033 (425) 242-7490

CODES AND COMPLIANCES

2018 IRC, 2018 MSEC

FIRE SPRINKLER NOTE

AN NFPAI3D FIRE SPRINKLER SYSTEM IS REQUIRED. EACH UNIT (LOT) IS SEPERATED BY AN I" INCH AIR SPACE AND EACH UNIT'S ONE HOUR PARTY WALL PER DETAIL ON A-12

HEATING NOTE

ELECTRIC DUCTLESS HEAT PUMP HEAT FOR ALL PRIMARY SPACES

TABLE OF CONTENTS

AI- FRONT ELEVATION

AI.I- REAR ELEVATION A2- SIDE ELEVATIONS

A3- FOUNDATION PLAN A4- LOWER FLOOR PLAN

A5- MAIN FLOOR FRAMING PLAN

A6- MAIN FLOOR PLAN

A7- UPPER FLOOR FRAMING PLAN

A8- UPPER FLOOR PLAN A9- ROOF FRAMING PLAN

AIO- BUILDING SECTIONS & WSEC

DI- RATED WALL DETAILS LI- LATERAL DETAILS

GI- TYPICAL WALL-DESIGN DATA

UNIT TYPE 'A' SQUARE FOOTAGE'S:

LOWER FLOOR	416 S.F.
MAIN FLOOR	762 S.F.
UPPER FLOOR	728 S.F.
TOTAL	1906 S.F.
GARAGE	212 S.F.

UNIT TYPE 'B' SQUARE FOOTAGE'S:

SCALE: 1/4" = 1'-0"

LOWER FLOOR MAIN FLOOR UPPER FLOOR	416 S.F. 762 S.F. 696 S.F.
TOTAL	1874 S.F.
GARAGE	212 S.F.

FLASHING NOTE

APPROVED CORROSION-RESISTANT FLASHING SHALL BE APPLIED SHINGLE FASHION IN SUCH A MANNER TO PREVENT ENTRY OF WATER INTO THE WALL CAVITY OR PENETRATION OF WATER INTO THE BUILDING STRUCTURAL FRAMING COMPONENTS THE FLASHING SHALL EXTEND TO THE SURFACE OF THE EXTERIOR WALL FINISH. APPROVED CORROSION

RESISTANT FLASHING SHALL BE INSTALLED AT THE FOLLOWING LOCATIONS: I. EXTERIOR WINDOW AND DOOR OPENINGS. FLASHING AT EXTERIOR WINDOW AND DOOR OPENINGS SHALL EXTEND TO THE SURFACE OF THE EXTERIOR WALL FINISH OR TO THE WATER RESISTIVE BARRIER FOR SUBSEQUENT

2. AT THE INTERSECTION OF CHIMNEYS OR OTHER MASONRY CONSTRUCTION WITH FRAME OR STUCCO WALLS

3. UNDER AND AT THE ENDS OF MASONRY, WOOD, OR METAL COPINGS AND SILLS

4. CONTINUOUSLY ABOVE ALL PROJECTING WOOD TRIM


5. WHERE EXTERIOR PORCHES, DECKS, OR STAIRS ATTACH TO A WALL OR FLOOR ASSEMBLY OF WOOD FRAME CONSTRUCTION

6. AT WALL AND ROOF INTERSECTIONS

7. AT BUILT IN GUTTERS

ADDRESS NOTE:

ADDRESS NUMBERS SHALL BE A MINIMUM 4" HIGH WITH A MINIMUM STROKE WIDTH OF 1/2" AND TO BE ON A CONTRASTING BACKGROUND PER IRC 319.1

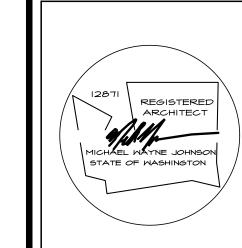


SF

Z

6-22-22 permit: revisions:

drawn by: LMD checked by: MMJ

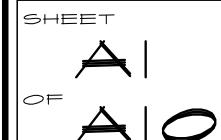

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REAR ELEVATION

SCALE: 1/4" = 1'-0" SEE GENERAL NOTES

REAR/SIDE FACADE CALCULATIONS

PER COUNTY DESIGN CODE, 10% OF REAR/S .FACING FACADE MUST BE TRANSPARENCY FACADE AREA = 2289 SQFT

TRANSPARENCY AREA = 527.5 SQFT (23.0%)


(FACADE SQFT VERIFIED USING AUTOCAD AREA COMMAND TO GET EXACT SQFT)

REGISTERED MICHAEL WAYNE JOHNSON STATE OF WASHINGTON


6-22-22

date: permit: revisions:

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HOLDDOWN SCHEDULE						
MARK	1ARK HOLDOWN/ FASTENERS WOOD MEMBER STRAP THICKNESS/SPECIES					
T-I	STHD14/14 RJ	24-16d SINKERS	(2) 2X4/2X6 STUDS HF/SPF			
T-2	MST48	(34)-16d	(2) 2X4/2X6 STUDS HF/SPF			
T-3	MST72	MST72 (68)-10d (2) 2X4/2X6 STUI HF/SPF				
T-4	MSTC48B3	(38)-10d	(2) 2X4/2X6 STUDS HF/SPF			
T-5	HDU8-SDS2.5	(20) SDS 1/4" X 2-1/2"	(2) 2X4/2X6 STUDS HF/SPF	7/8" ANCHOR BOLT		
T-6	HDI2	(4) I" STUD BOLTS	(3) 2X4/2X6 STUDS HF/SPF	SBIX30 MIN. EMBEDMENT IS 24" WALL MINIMUM 30" TALL WALL AT THESE LOCATIONS		

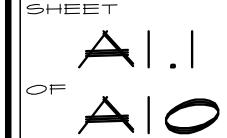SHEAR NOTE:

I. 3X MATERIAL CAN BE USED FOR ALL MUDSILLS 2. SET A DOUBLE 2X STUD BEHIND EVERY STHDI4 HOLDOWN CALLED OUT
ON THE FOUNDATION PLAN. SET HOLDOWN
1/2" MINIMUM AWAY FROM WALL CORNERS,
WINDOW AND DOOR HEADERS. IT IS IMPORTANT THAT THE FOUNDATION CONTRACTOR HAS THE MAIN FLOOR PLAN SHEET TO PROPERLY LAYOUT HOLDOWNS. 3. A MST48 STRAP WITH (2) 1/2" BOLTS INTO THE FOUNDATION IS A PROPER FIX FOR A MISPLACED STHD14 HOLDOWN.

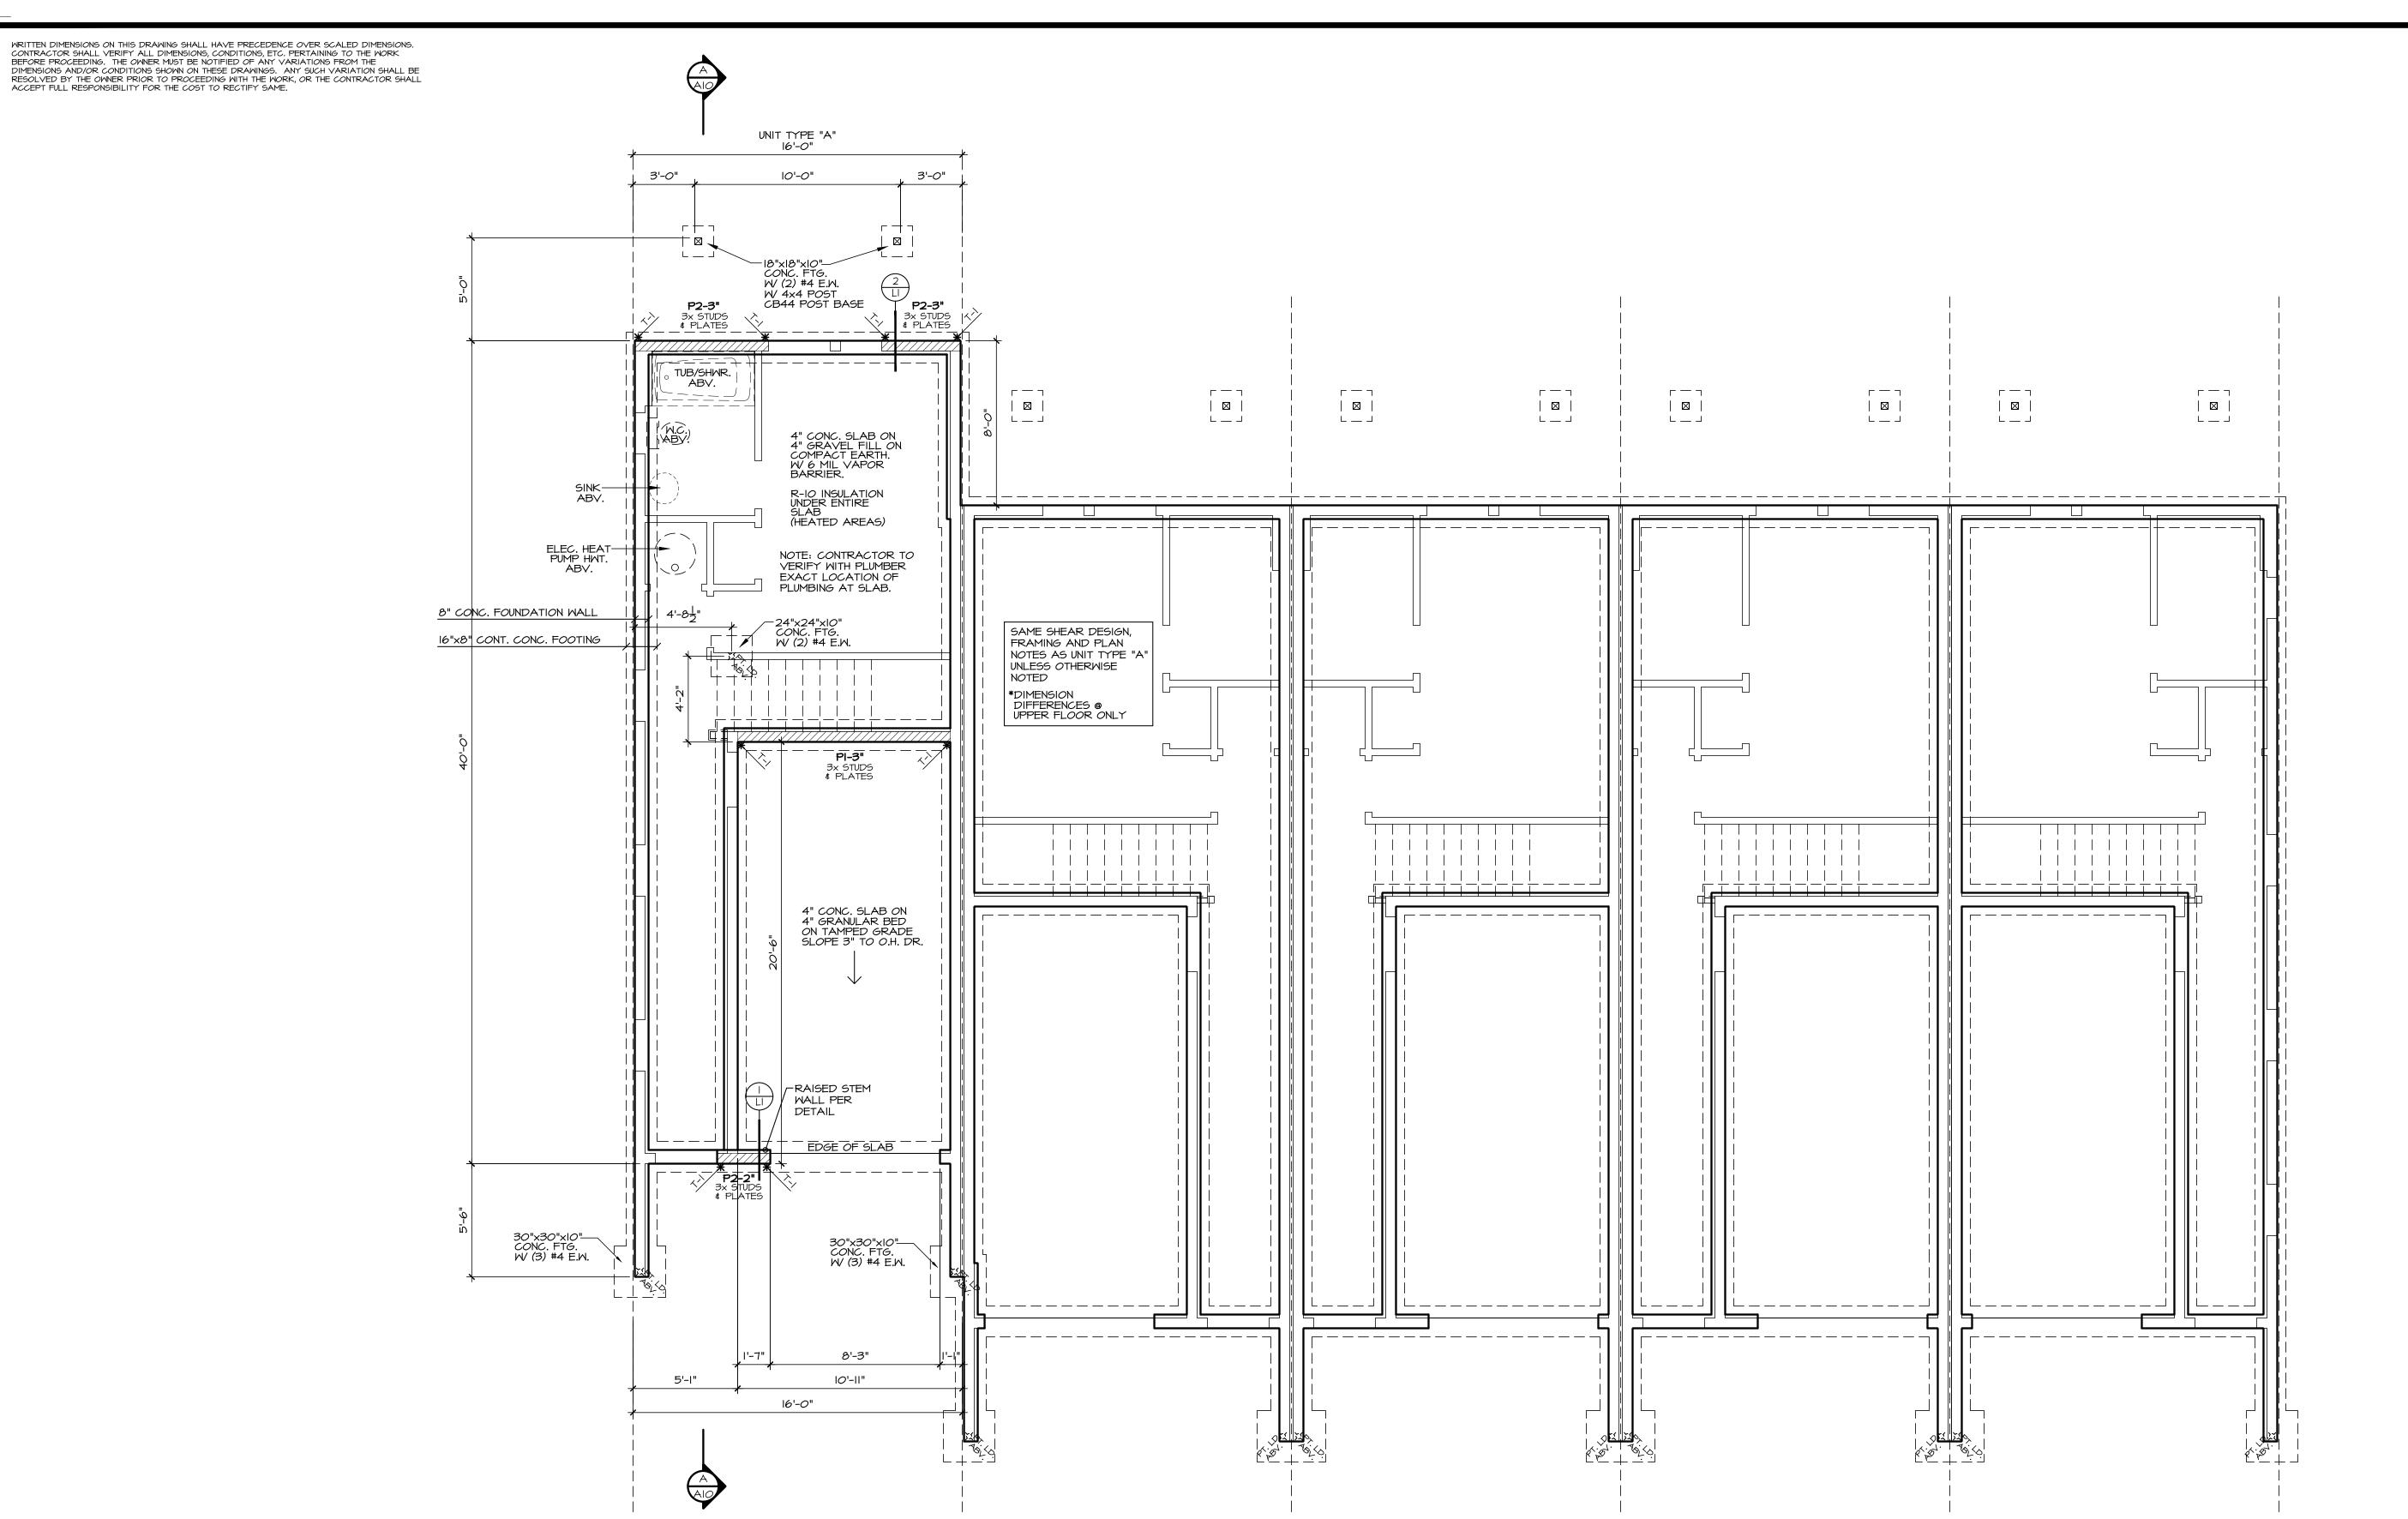ALL WOOD IN CONTACT WITH CONCRETE SHALL BE PRESSURE TREATED OR CEDAR. PROVIDE CRAWL DRAIN @ LOW POINT IN CRAWLSPACE.

SOLID BLOCKING UNDER ALL BEARING WALLS.

SLOPE ALL CONC. STOOPS AND/OR PATIOS 1/4" PER FOOT AWAY FROM DOORWAYS.

*** SHEAR NOTE: SEE SHEET LI FOR SHEAR WALL NAILING SCHEDULE, & DETAILS. FOUNDATION PLAN

SEE GENERAL NOTES

SCALE: 1/4" = 1'-0"


REGISTERED MICHAEL WAYNE JOHNSON STATE OF WASHINGTON

> * ASSOCIATES HITECTS NASH

6-22-22 | permit:

revisions:

drawn by: LMD checked by: MMJ SHEET

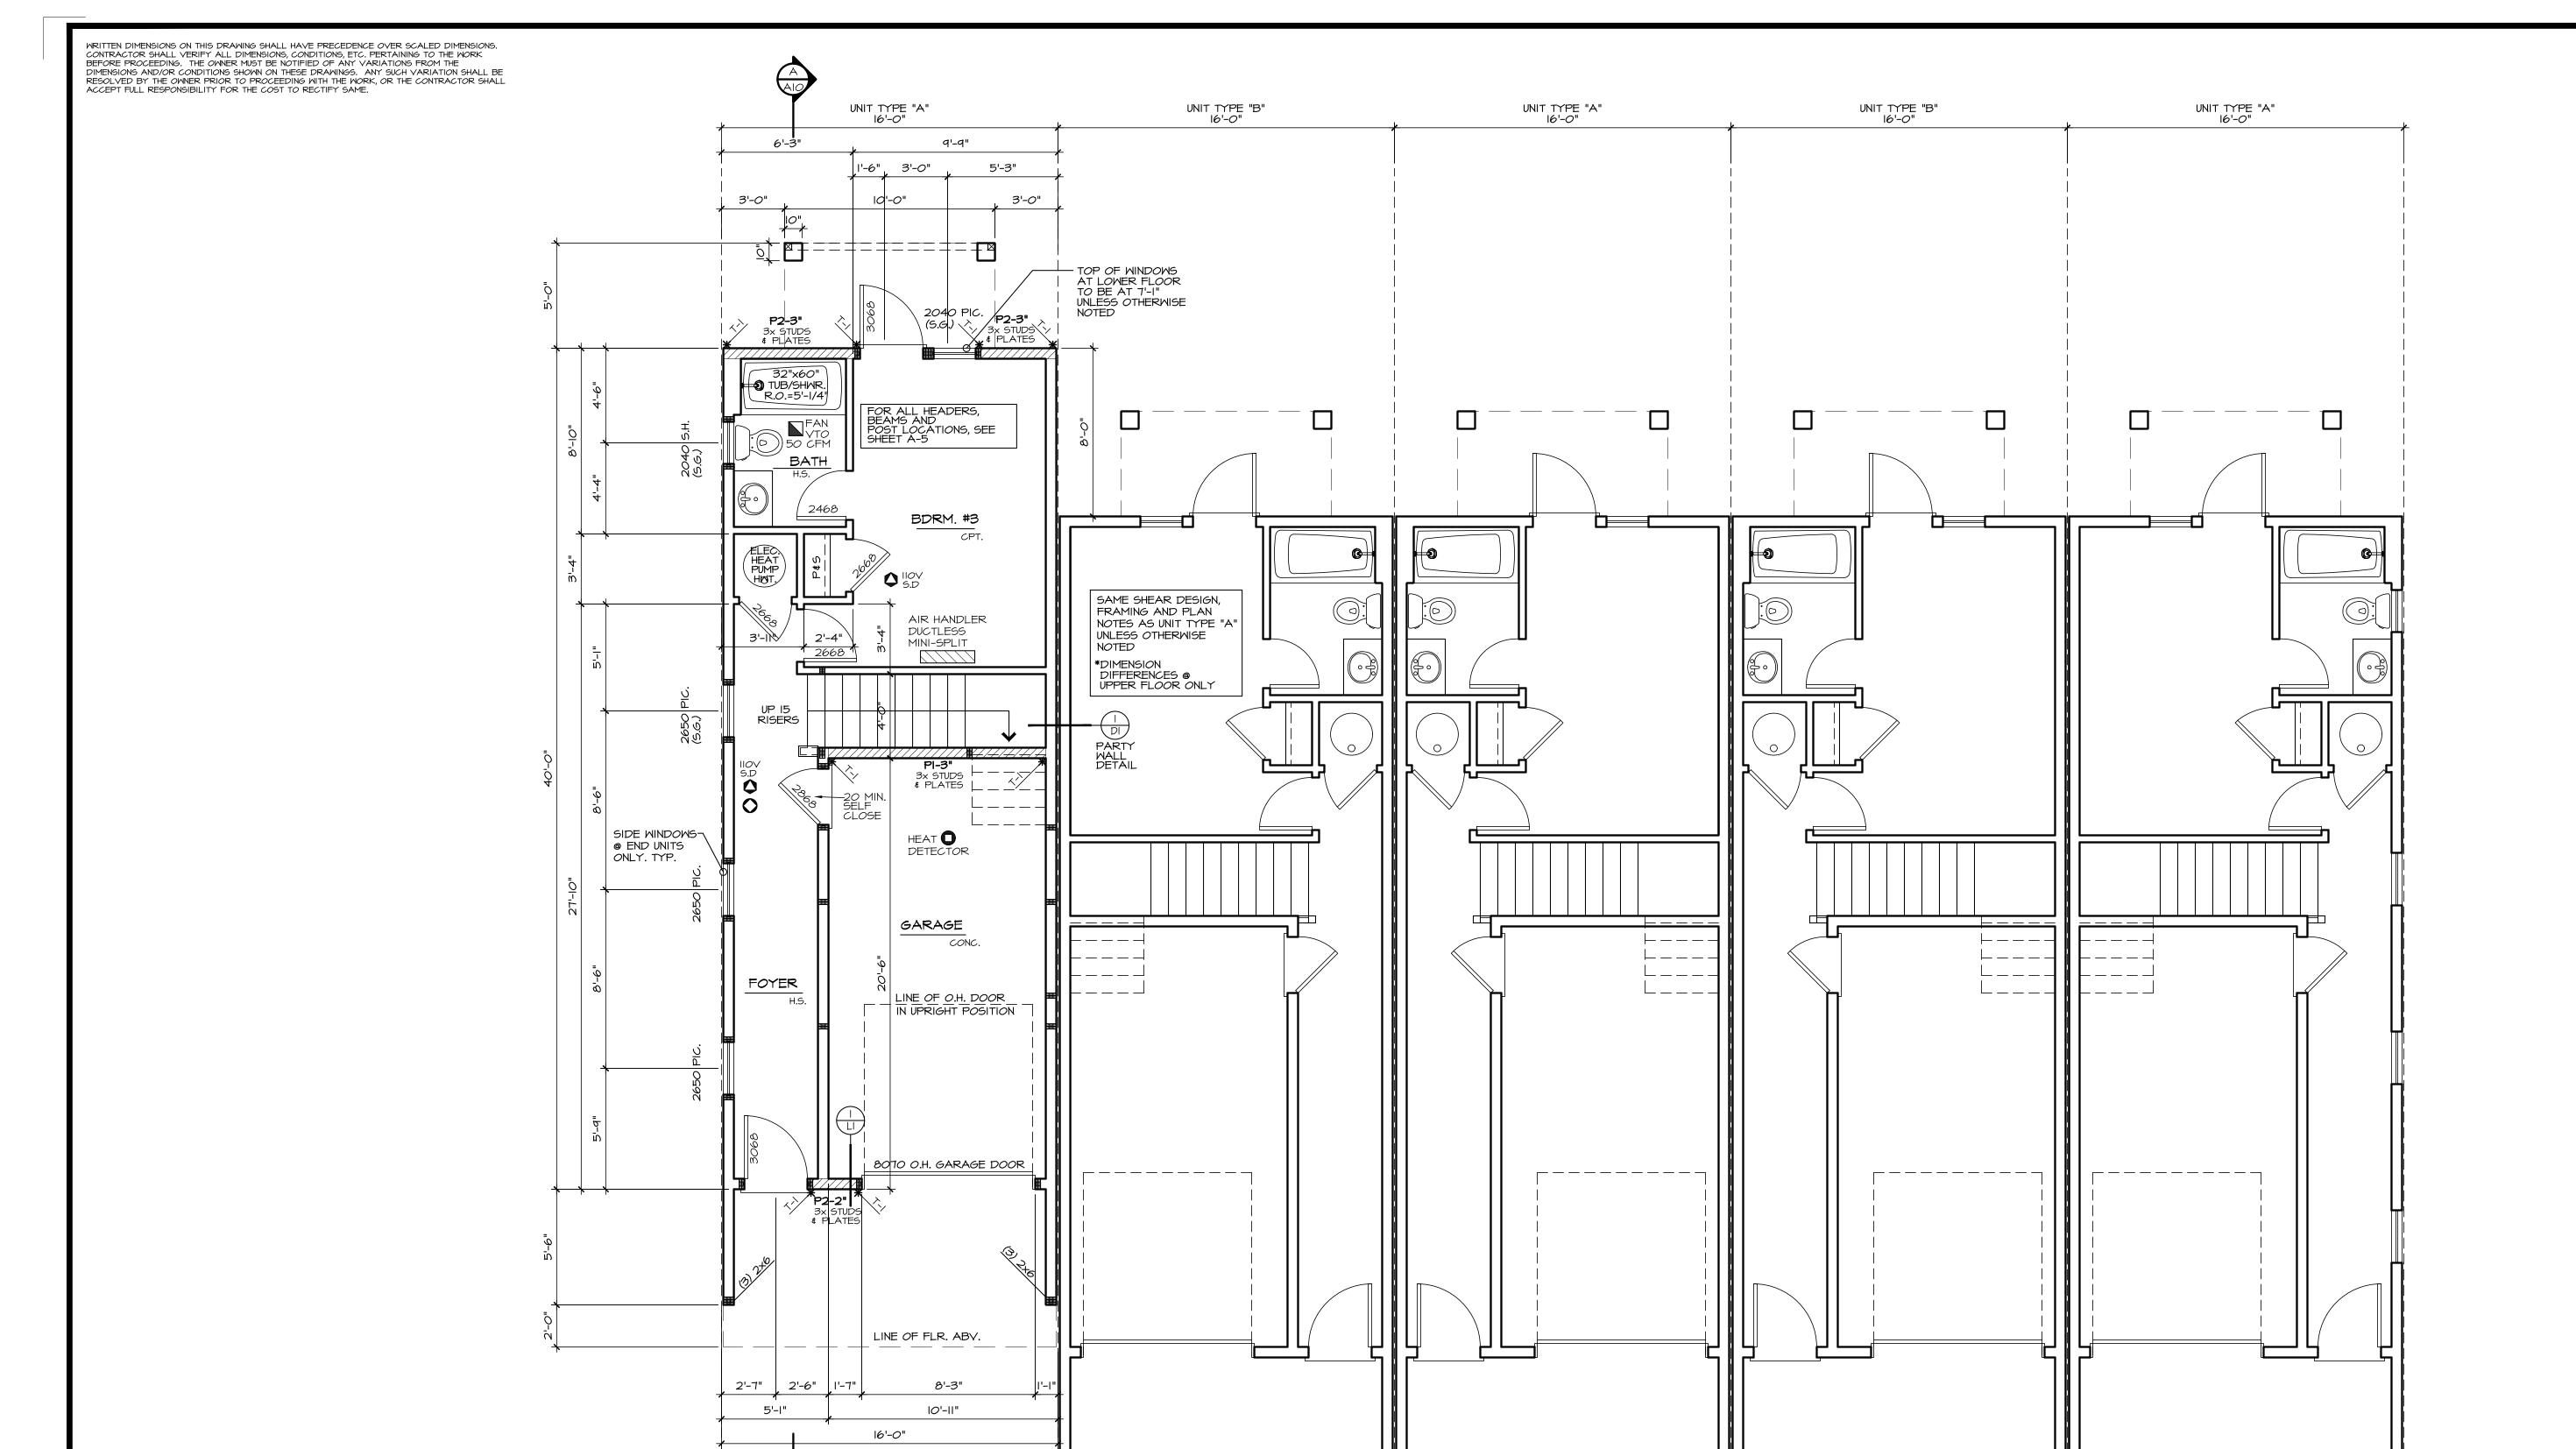

HOLDDOWN SCHEDULE					
MARK	HOLDOWN/ STRAP	FASTENERS	WOOD MEMBER THICKNESS/SPECIES	ANCHOR REQUIRED	
Т-1	STHD14/14 RJ	24-16d SINKERS	(2) 2X4/2X6 STUDS HF/SPF		
T-2	MST48	(34)-16d	(2) 2X4/2X6 STUDS HF/SPF		
T-3	MST72 (68)-10d		(2) 2X4/2X6 STUDS HF/SPF		
T-4	MSTC48B3	(38)-10d	(2) 2X4/2X6 STUDS HF/SPF		
T-5	HDU8-SDS2.5	(20) SDS 1/4" X 2-1/2"	(2) 2X4/2X6 STUDS HF/SPF	7/8" ANCHOR BOLT	
T-6	HDI2	(4) I" STUD BOLTS	(3) 2X4/2X6 STUDS HF/SPF	SBIX30 MIN, EMBEDMENT IS 24" WALL MINIMUM 30" TALL WALL AT THESE LOCATIONS	

ALL EXTERIOR WARM WALLS TO BE 2 X 6 STUDS @ 16" O.C. TYPICAL.

ALL INTERIOR WALLS TO BE 2 X 4 STUDS @ 16" O.C. TYPICAL.

ALL HEADERS TO BE 4XIO DF#2 UNLESS NOTED OTHERWISE.

FUR-OUT HEADERS TO MATCH 2 X 6 WALLS.

SOLID BLOCKING UNDER ALL BEARING WALLS.

TUB/SHOWER UNITS SHALL HAVE FIRE BLOCKING BETWEEN WALL STUDS AND WATERPROOF SURROUNDS TO +72"
FROM DRAIN. GLAZING, INCLUDING WINDOWS WITHIN +72" OF DRAIN, SHALL BE SAFTEY GLASS. SHOWER FLOW IS LIMITED TO 1.75 GAL/MIN.

EXHAUST FANS LARGER THAN 50CFM MAY BE CONNECTED TO 4" SMOOTH WALL VENT PIPE IF RUNS DO NOT EXCEED 20' IN LENGTH. THE MINIMUM SIZE OF FLEX DUCT IS 5" DIAMETER WITH A MAXIMUM RUN OF 15'

COMBUSTION AIR REQUIRED FOR ALL FUEL BURNING APPLIANCES

BEARING ABOVE

FLOOR LINE ABOVE

PT. LD. X
POINT LOAD ABOVE

MULTIPLE 2x STUDS

POINT LOAD

SMOKE DETECTOR

IIOV INTERCONNECTED

W/ BATTERY BACK-UP.

PER IRC 314

CARBON MONOXIDE DETECTOR
PER IRC 315

HEAT DETECTOR

*** SHEAR NOTE:

SEE SHEET LI FOR SHEAR WALL
NAILING SCHEDULE, & DETAILS.

SMOKE DETECTORS SHALL BE INSTALLED
NOT LESS THAN 3 FEET HORIZONTALLY
FROM THE DOOR OR OPENING OF A
BATHROOM THAT CONTAINS A TUB
OR SHOWER PER R314

LONIZATION SMOKE ALARMS:
SHALL NOT BE INSTALLED LESS THAN
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ALARM SILENCING SWITCH SHALL NOT
BE INSTALLED LESS THAN IO' HORIZONTALLY
FROM A PERMANENTLY INSTALLED COOKING
APPLIANCE.

PHOTO ELECTRIC SMOKE ALARMS:
SHALL NOT BE INSTALLED LESS THAN 6'
HORIZONTALLY FROM A PERMANENTLY
INSTALLED COOKING APPLIANCE PER R314

REGISTERED ARCHITECT

MICHAEL WAYNE JOHNSON STATE OF WASHINGTON

NASH & ASSOCIATES

ARCHITECTS

8003 118TH AVE NE. KIRKLAND, WA. 98033. 425-828-4117

www.nash-architects.com

YARDARM GROUP POPLAR POINT UNITS 1-5

date: 6-22-22 permit: revisions:

drawn by: LMD checked by: MMJ


SHEET

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OF

LOMER FLOOR PLAN

SEE GENERAL NOTES

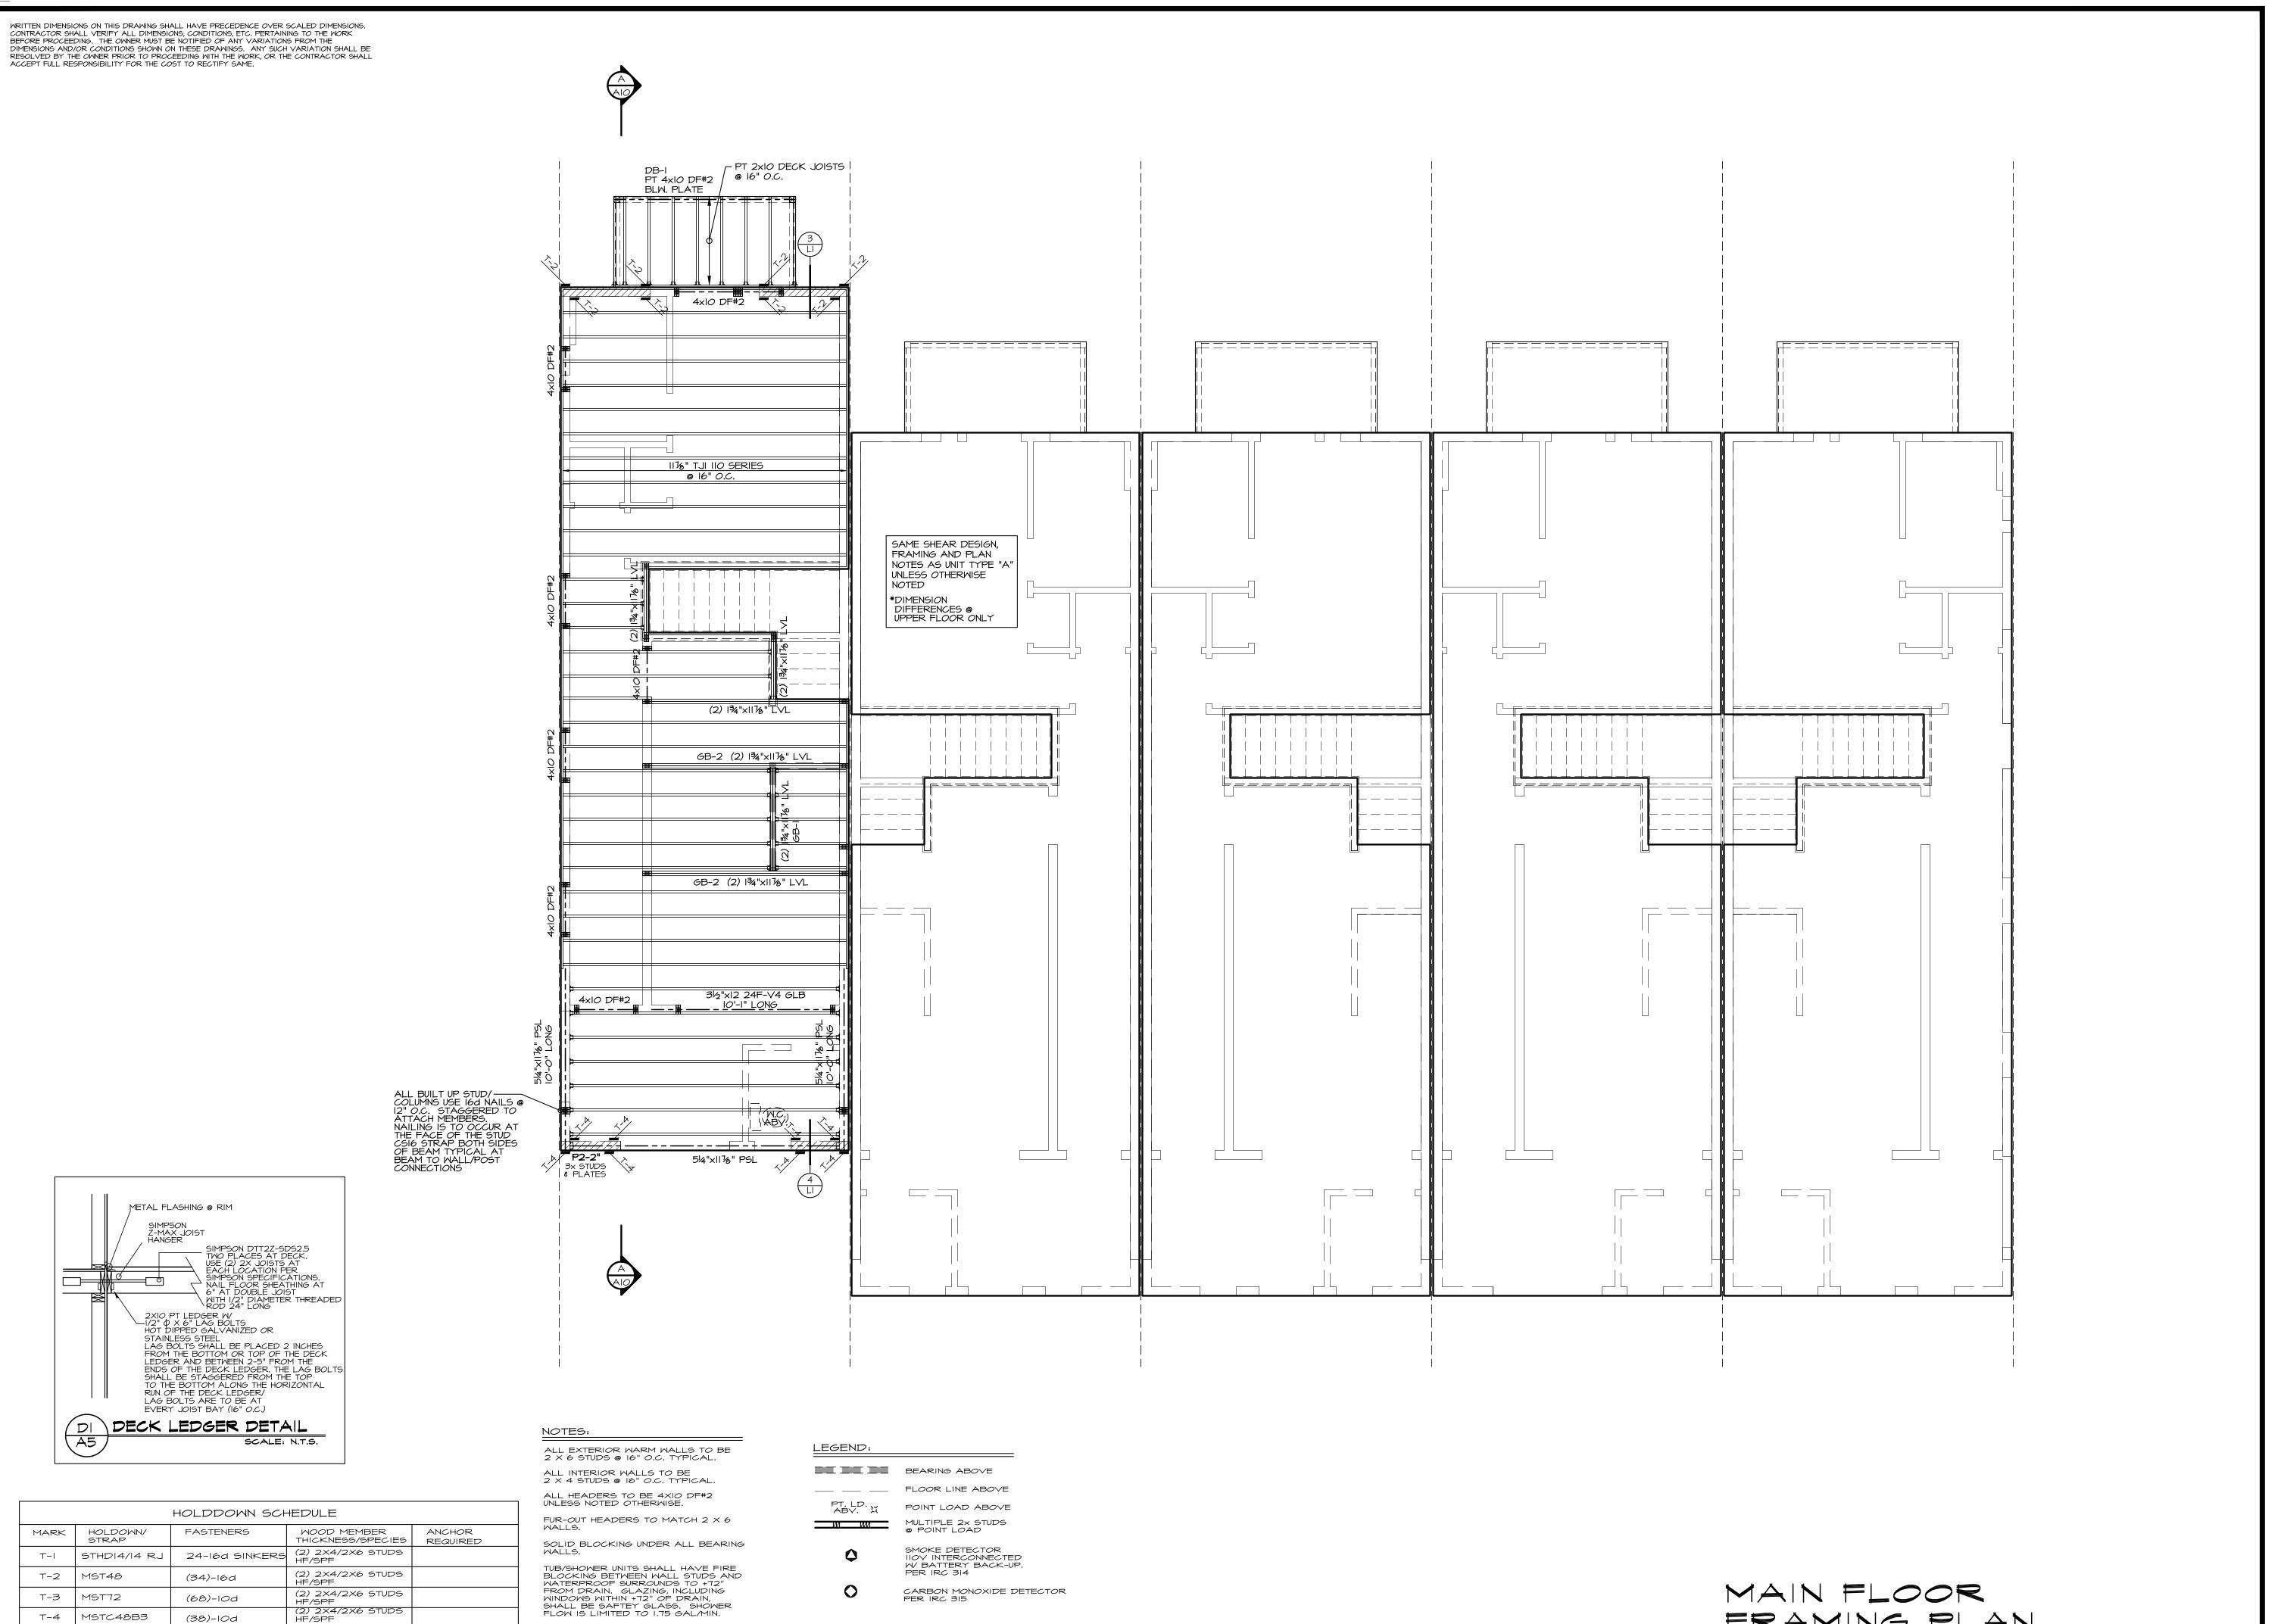

EXHAUST FANS LARGER THAN 50CFM MAY BE

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SEE SHEET LI FOR SHEAR WALL NAILING SCHEDULE, & DETAILS.

7/8" ANCHOR BOLT

SBIX30 MIN. EMBEDMENT IS 24" WALL MINIMUM 30" TALL WALL AT THESE LOCATIONS

(2) 2X4/2X6 STUDS HF/SPF

(3) 2X4/2X6 STUDS HF/SPF

T-5


T-6

HDU8-SDS2.5

HD12

(20) SDS 1/4"

BOLTS

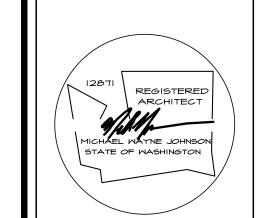


6-22-22 permit: revisions:

drawn by: LMD checked by: MMJ SHEET

FRAMING PLAN

SEE GENERAL NOTES

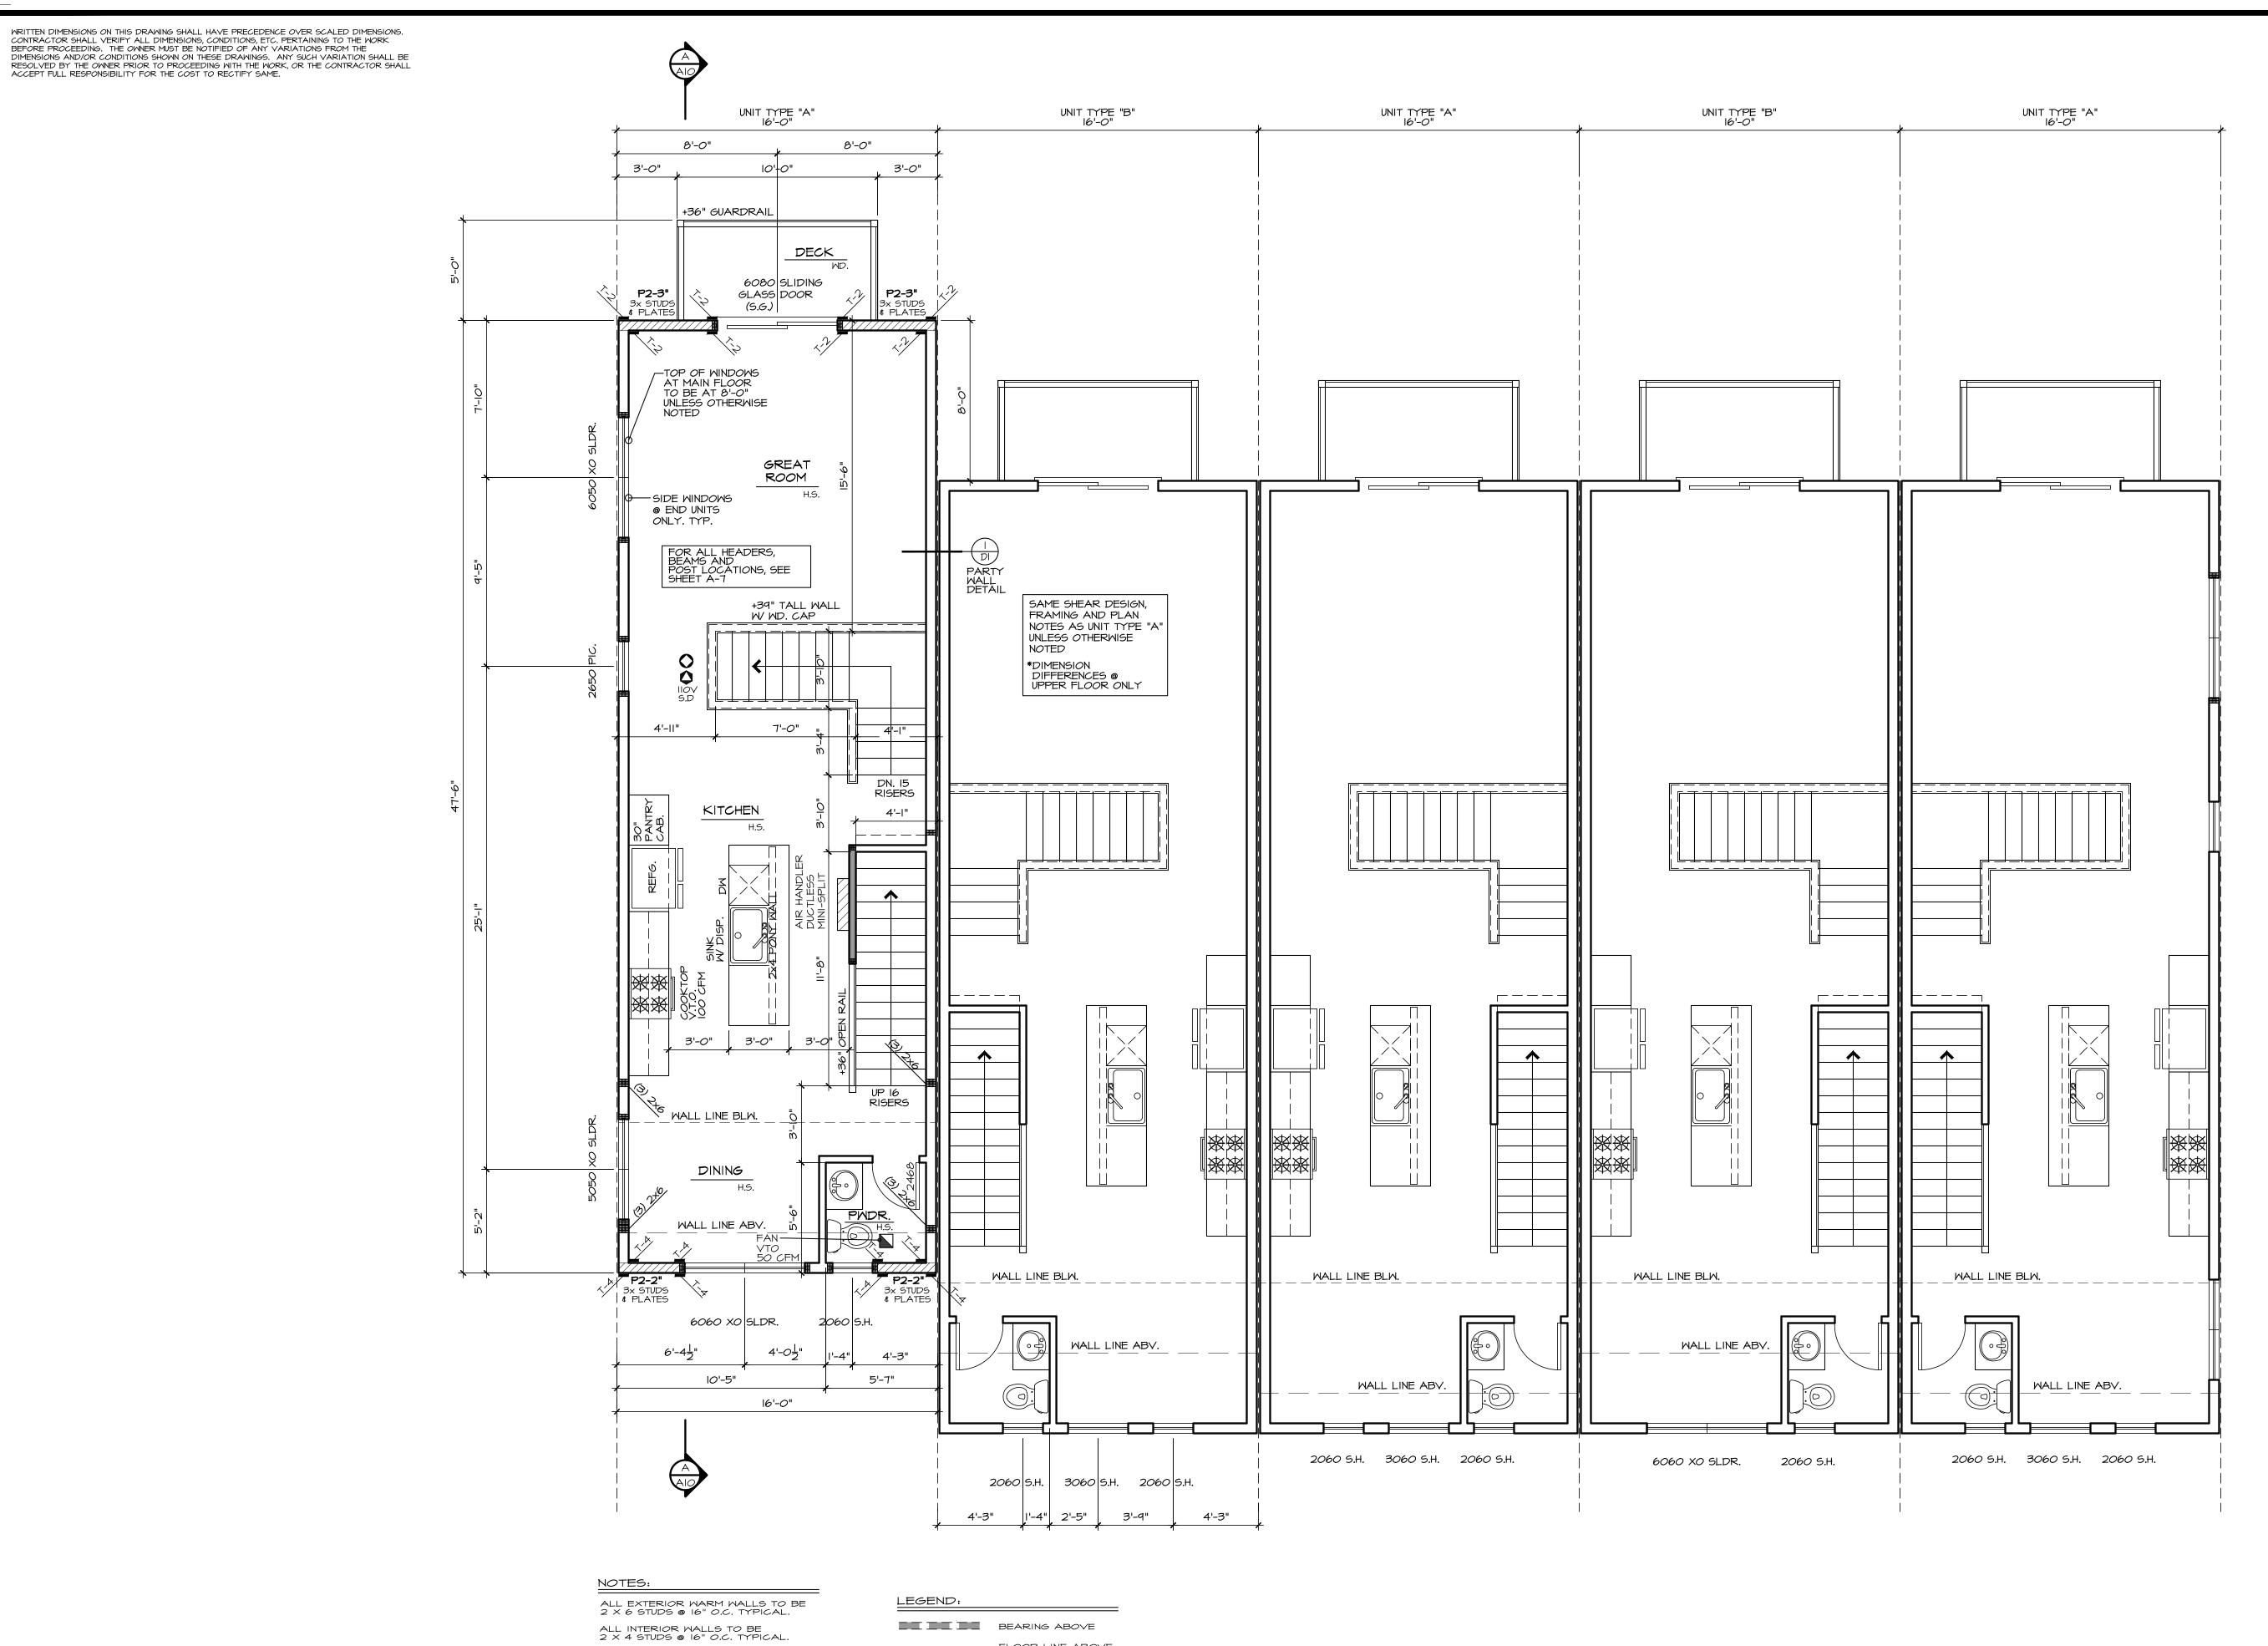

HOLDDOWN SCHEDULE					
MARK	HOLDOWN/ STRAP	ANCHOR REQUIRED			
T-I	STHD14/14 RJ	24-16d SINKERS	(2) 2X4/2X6 STUDS HF/SPF		
T-2	MST48	(34)-16d	(2) 2X4/2X6 STUDS HF/SPF		
T-3	MST72	(68)-10d	(2) 2X4/2X6 STUDS HF/SPF		
T-4	MSTC48B3	(38)-10d	(2) 2X4/2X6 STUDS HF/SPF		
T-5	HDU8-SDS2.5	(20) SDS 1/4" X 2-1/2"	(2) 2X4/2X6 STUDS HF/SPF	7/8" ANCHOR BOLT	
T-6	HDI2	(4) I" STUD BOLTS	(3) 2X4/2X6 STUDS HF/SPF	SBIX30 MIN. EMBEDMENT IS 24" WALL MINIMUM 30" TALL WALL AT THESE LOCATIONS	

ALL HEADERS TO BE 4X10 DF#2 UNLESS NOTED OTHERWISE. FUR-OUT HEADERS TO MATCH 2 \times 6 WALLS. SOLID BLOCKING UNDER ALL BEARING WALLS.

TUB/SHOWER UNITS SHALL HAVE FIRE BLOCKING BETWEEN WALL STUDS AND WATERPROOF SURROUNDS TO +72" FROM DRAIN. GLAZING, INCLUDING WINDOWS WITHIN +72" OF DRAIN, SHALL BE SAFTEY GLASS. SHOWER FLOW IS LIMITED TO 1.75 GAL/MIN.

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FLOOR LINE ABOVE POINT LOAD ABOVE MULTIPLE 2x STUDS POINT LOAD

SMOKE DETECTOR
IIOV INTERCONNECTED
W/ BATTERY BACK-UP.
PER IRC 314

CARBON MONOXIDE DETECTOR PER IRC 315

*** SHEAR NOTE: SEE SHEET LI FOR SHEAR WALL NAILING SCHEDULE, & DETAILS. SMOKE DETECTORS SHALL BE INSTALLED NOT LESS THAN 3 FEET HORIZONTALLY FROM THE DOOR OR OPENING OF A BATHROOM THAT CONTAINS A TUB OR SHOWER PER R314


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APPLIANCE. APPLIANCE. PHOTO ELECTRIC SMOKE ALARMS:
SHALL NOT BE INSTALLED LESS THAN 6'
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INSTALLED COOKING APPLIANCE PER R314

MAIN FLOOR PLAN

SEE GENERAL NOTES

SCALE: 1/4" = 1'-0"

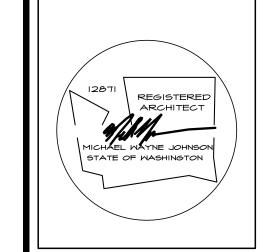


6-22-22 date: permit: revisions:

drawn by: LMD checked by: MMJ

SHEET



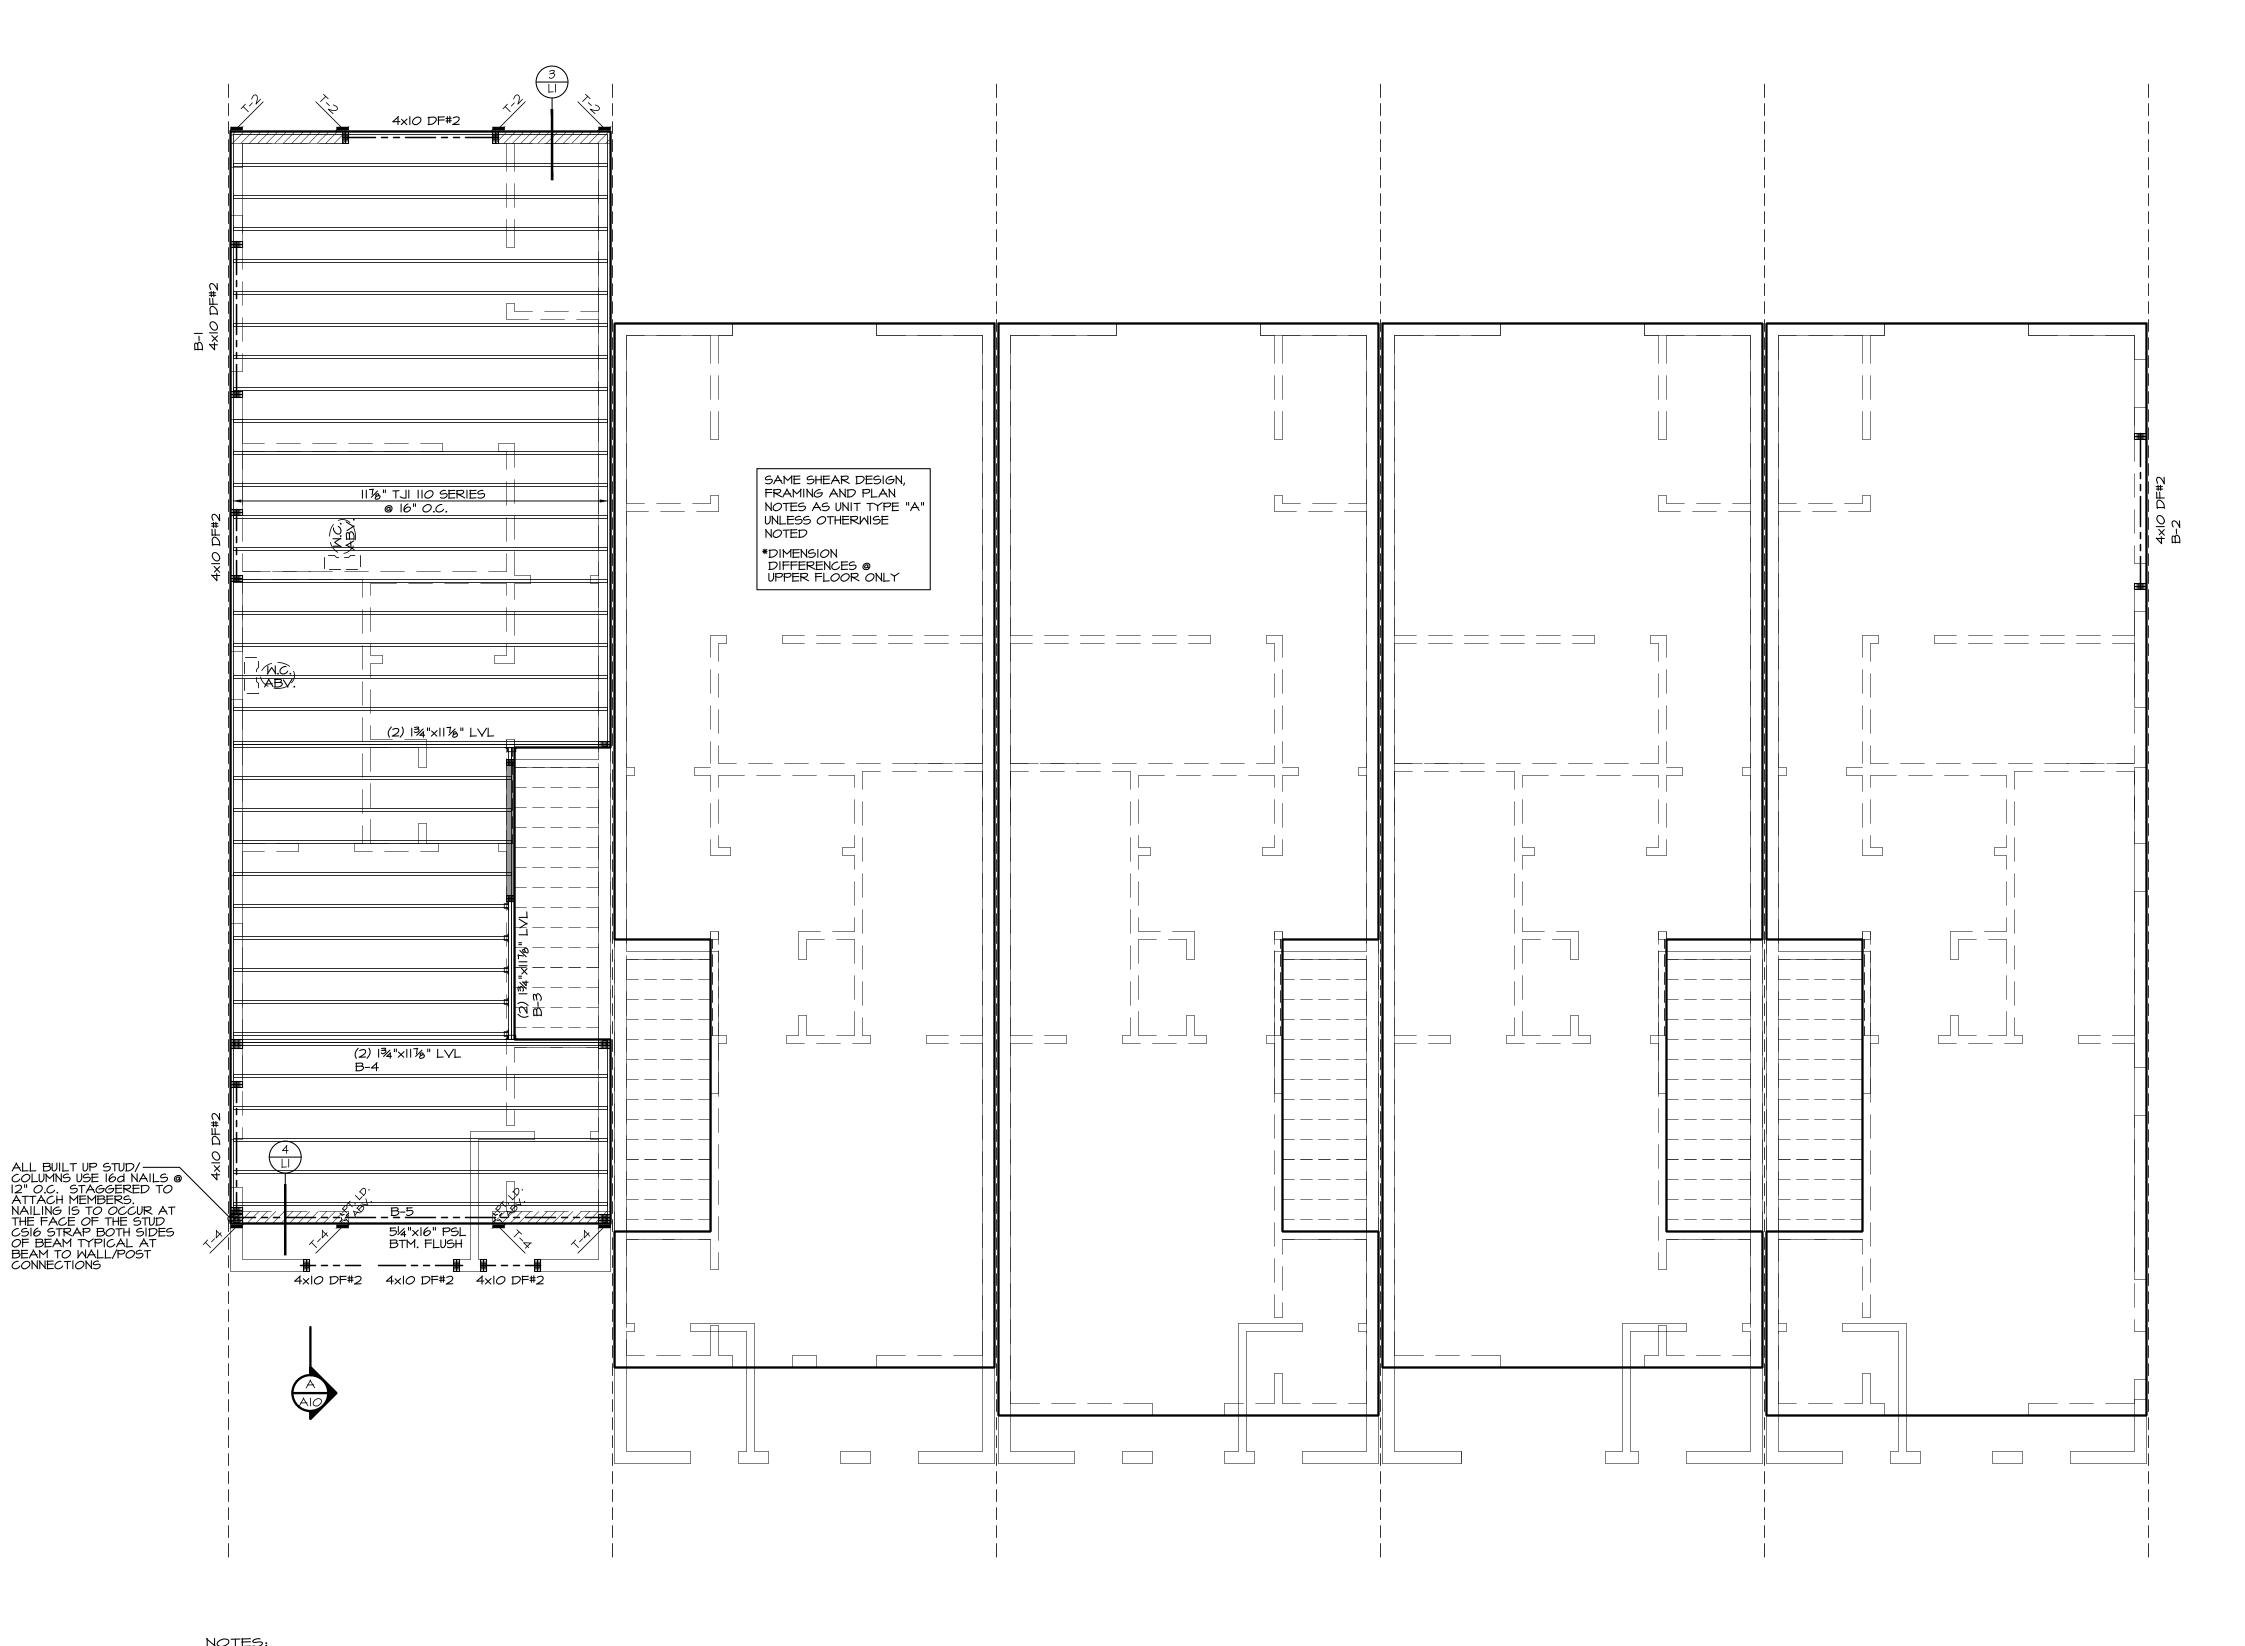

HOLDDOWN SCHEDULE					
MARK	HOLDOWN/ STRAP	ANCHOR REQUIRED			
T-I	STHD14/14 RJ	24-16d SINKERS	(2) 2X4/2X6 STUDS HF/SPF		
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LEGEND:

BEARING ABOVE

FLOOR LINE ABOVE

PT. LD.
POINT LOAD ABOVE

PT. LD. X POINT LOAD ABOVE

MULTIPLE 2x STUDS

POINT LOAD

SMOKE DETECTOR
IIOV INTERCONNECTED
W/ BATTERY BACK-UP.
PER IRC 314

CARBON MONOXIDE DETECTOR
PER IRC 315

*** SHEAR NOTE:

SEE SHEET LI FOR SHEAR WALL
NAILING SCHEDULE, & DETAILS.



SEE GENERAL NOTES

REGISTERED ARCHITECT

MICHAEL WAYNE JOHNSON STATE OF WASHINGTON

NASH & ASSOCIATES

ARCHITECTS

8003 118TH AVE NE. KIRKLAND, WA. 98033.425-828-4117

YARDARM GROUP POPLAR POINT UNITS 1-5

date: 6-22-22 permit: revisions:


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HOLDDOWN SCHEDULE								
MARK	MARK HOLDOWN/ FASTENERS WOOD MEMBER ANCHOR THICKNESS/SPECIES REQUIRED							
T-I	STHD14/14 RJ	24-16d SINKERS	(2) 2X4/2X6 STUDS HF/SPF					
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T-4	MSTC48B3	(38)-10d	(2) 2X4/2X6 STUDS HF/SPF					
T-5	HDU8-SDS2.5	(20) SDS 1/4" X 2-1/2"	(2) 2X4/2X6 STUDS HF/SPF	7/8" ANCHOR BOLT				
T-6	HDI2	(4) I" STUD BOLTS	(3) 2X4/2X6 STUDS HF/SPF	SBIX30 MIN. EMBEDMENT IS 24" MALL MINIMUM 30" TALL WALL AT THESE LOCATIONS				

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LEGEND:

PT. LD. X POINT LOAD ABOVE

MULTIPLE 2x STUDS

POINT LOAD

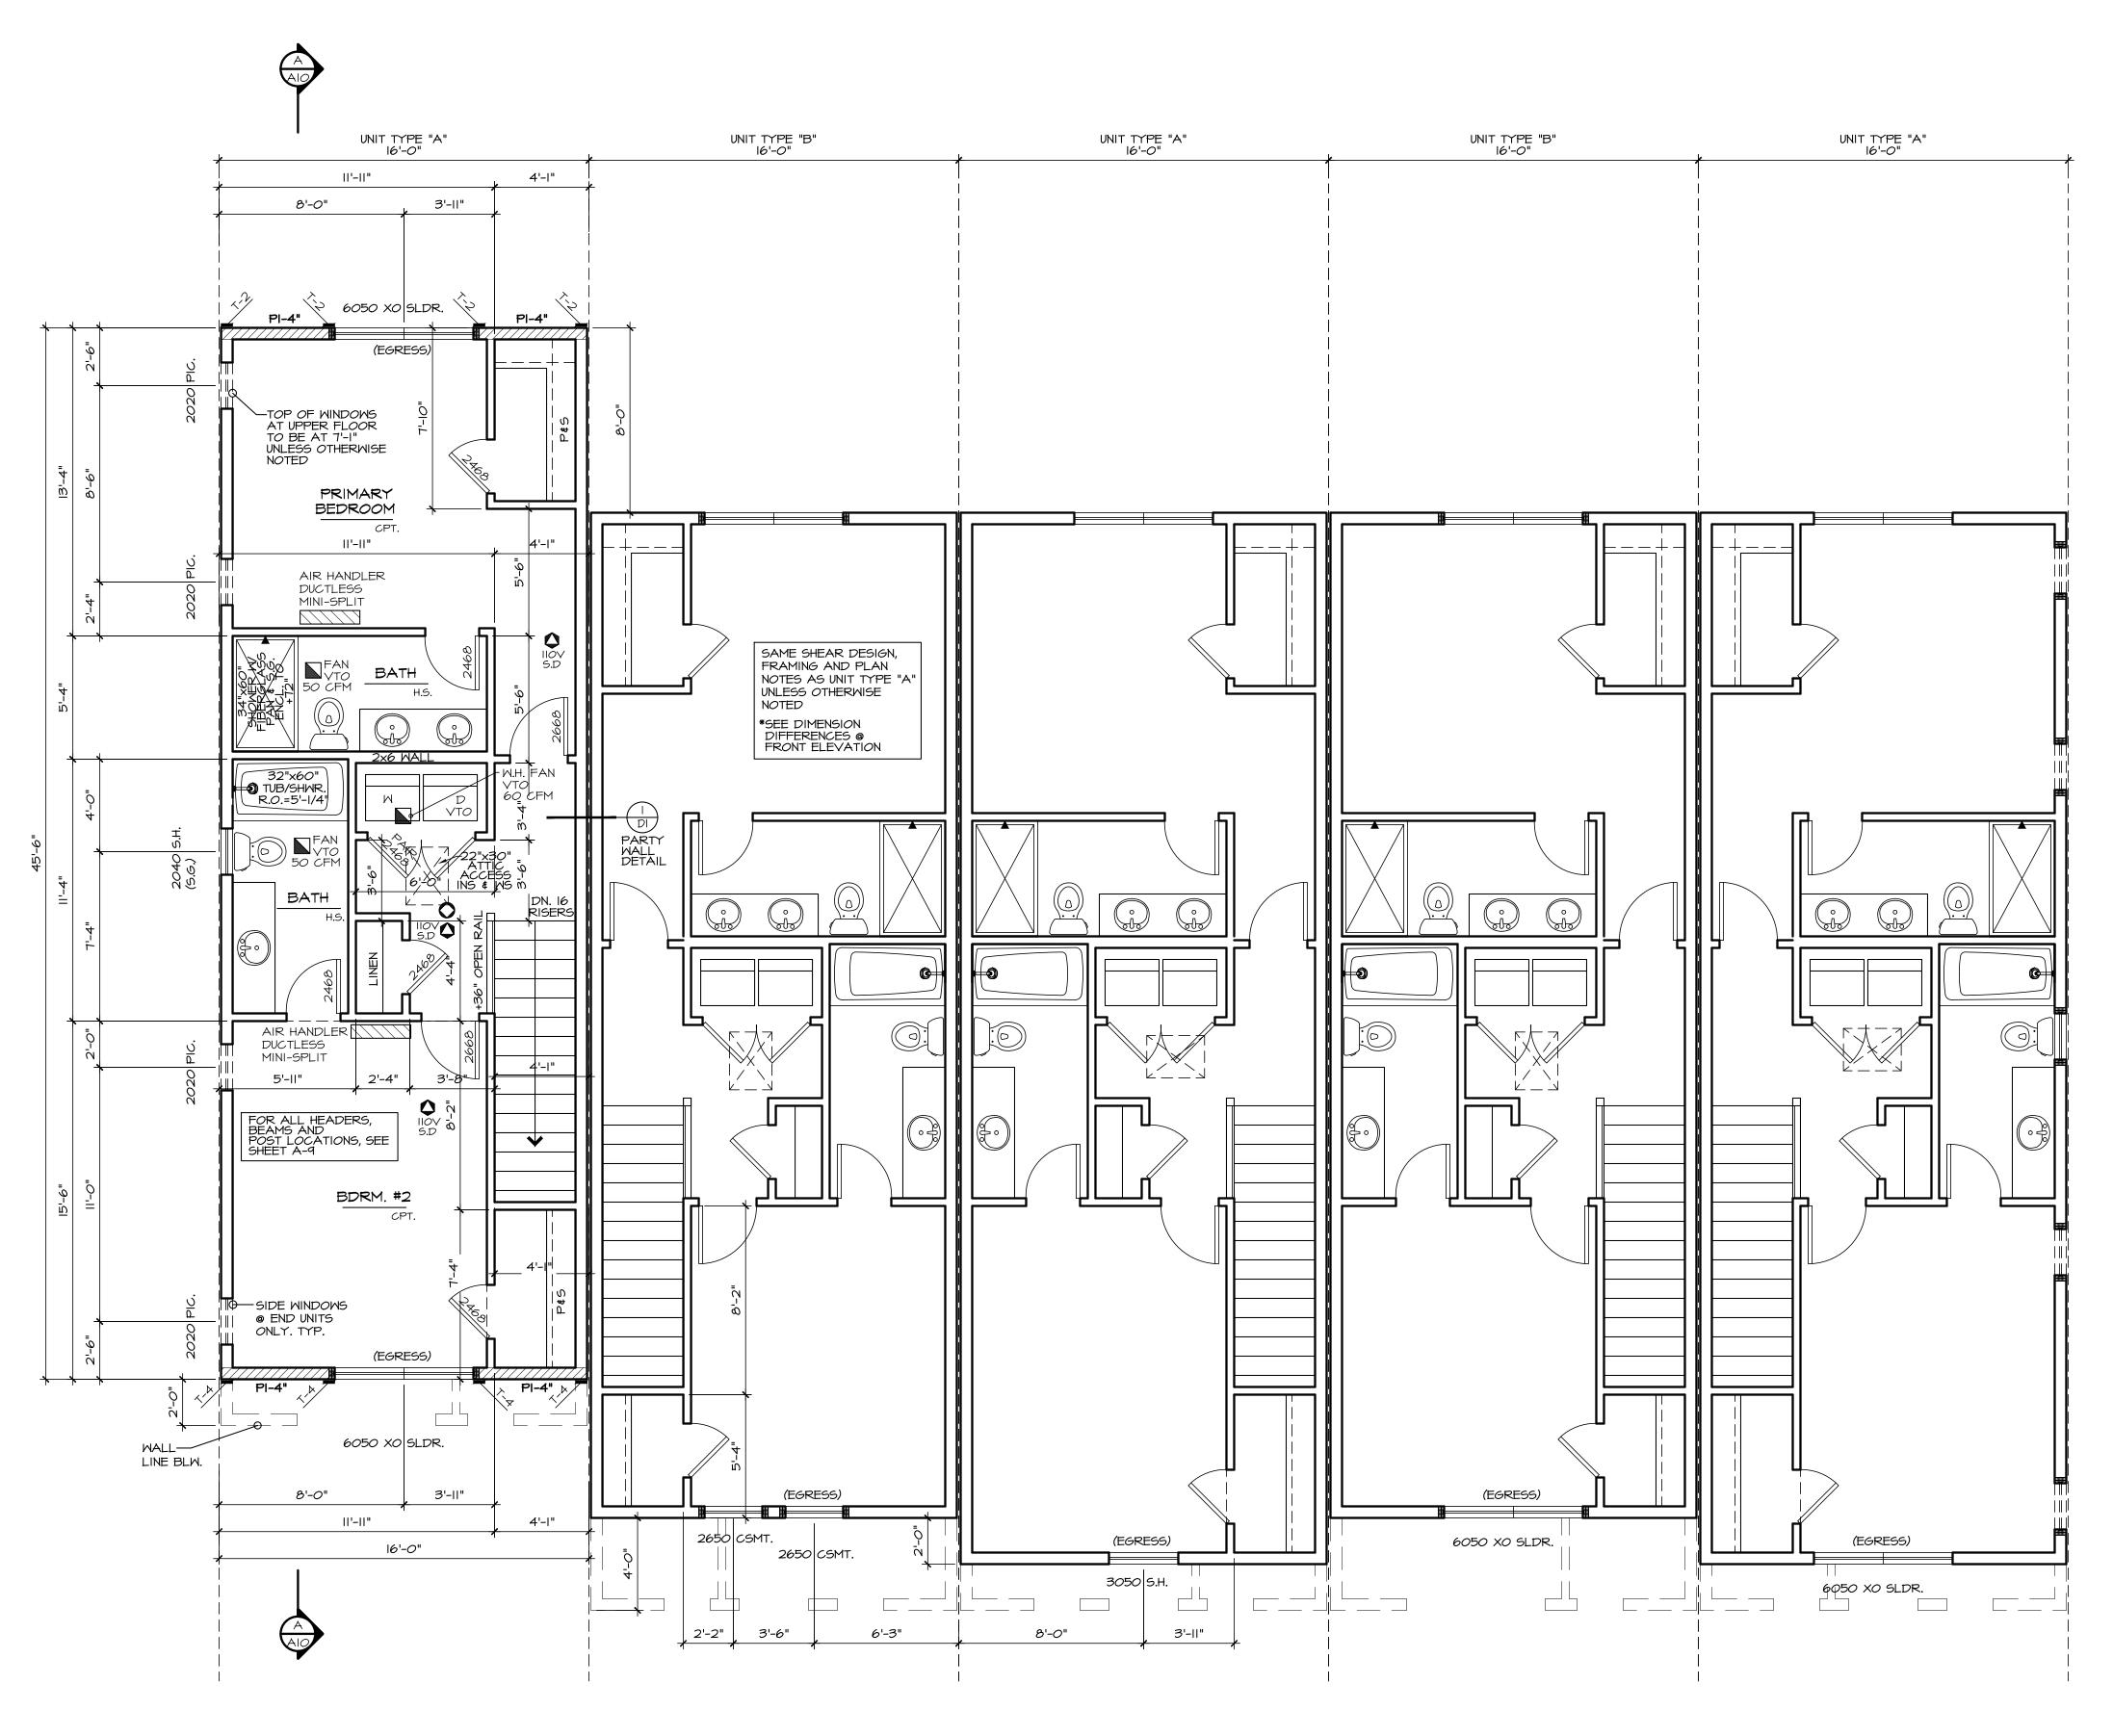SMOKE DETECTOR
IIOV INTERCONNECTED
W/ BATTERY BACK-UP.
PER IRC 314

CARBON MONOXIDE DETECTOR PER IRC 315

*** SHEAR NOTE:

SEE SHEET LI FOR SHEAR WALL
NAILING SCHEDULE, & DETAILS.

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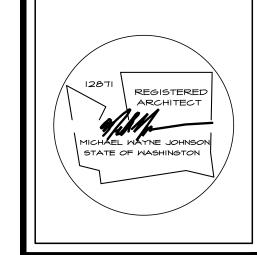
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PHOTO ELECTRIC SMOKE ALARMS:
SHALL NOT BE INSTALLED LESS THAN 6'
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INSTALLED COOKING APPLIANCE PER R314

UPPER FLOOR PLAN

SEE GENERAL NOTES



NASH & ASSOCIATES

ARCHITECTS


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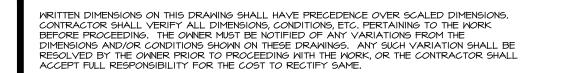
YARDARM GROUP POPLAR POINT UNITS 1-5


date: 6-22-22 permit: revisions:

drawn by: LMD checked by: MMJ

SHEET



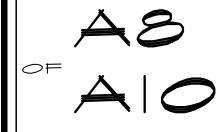

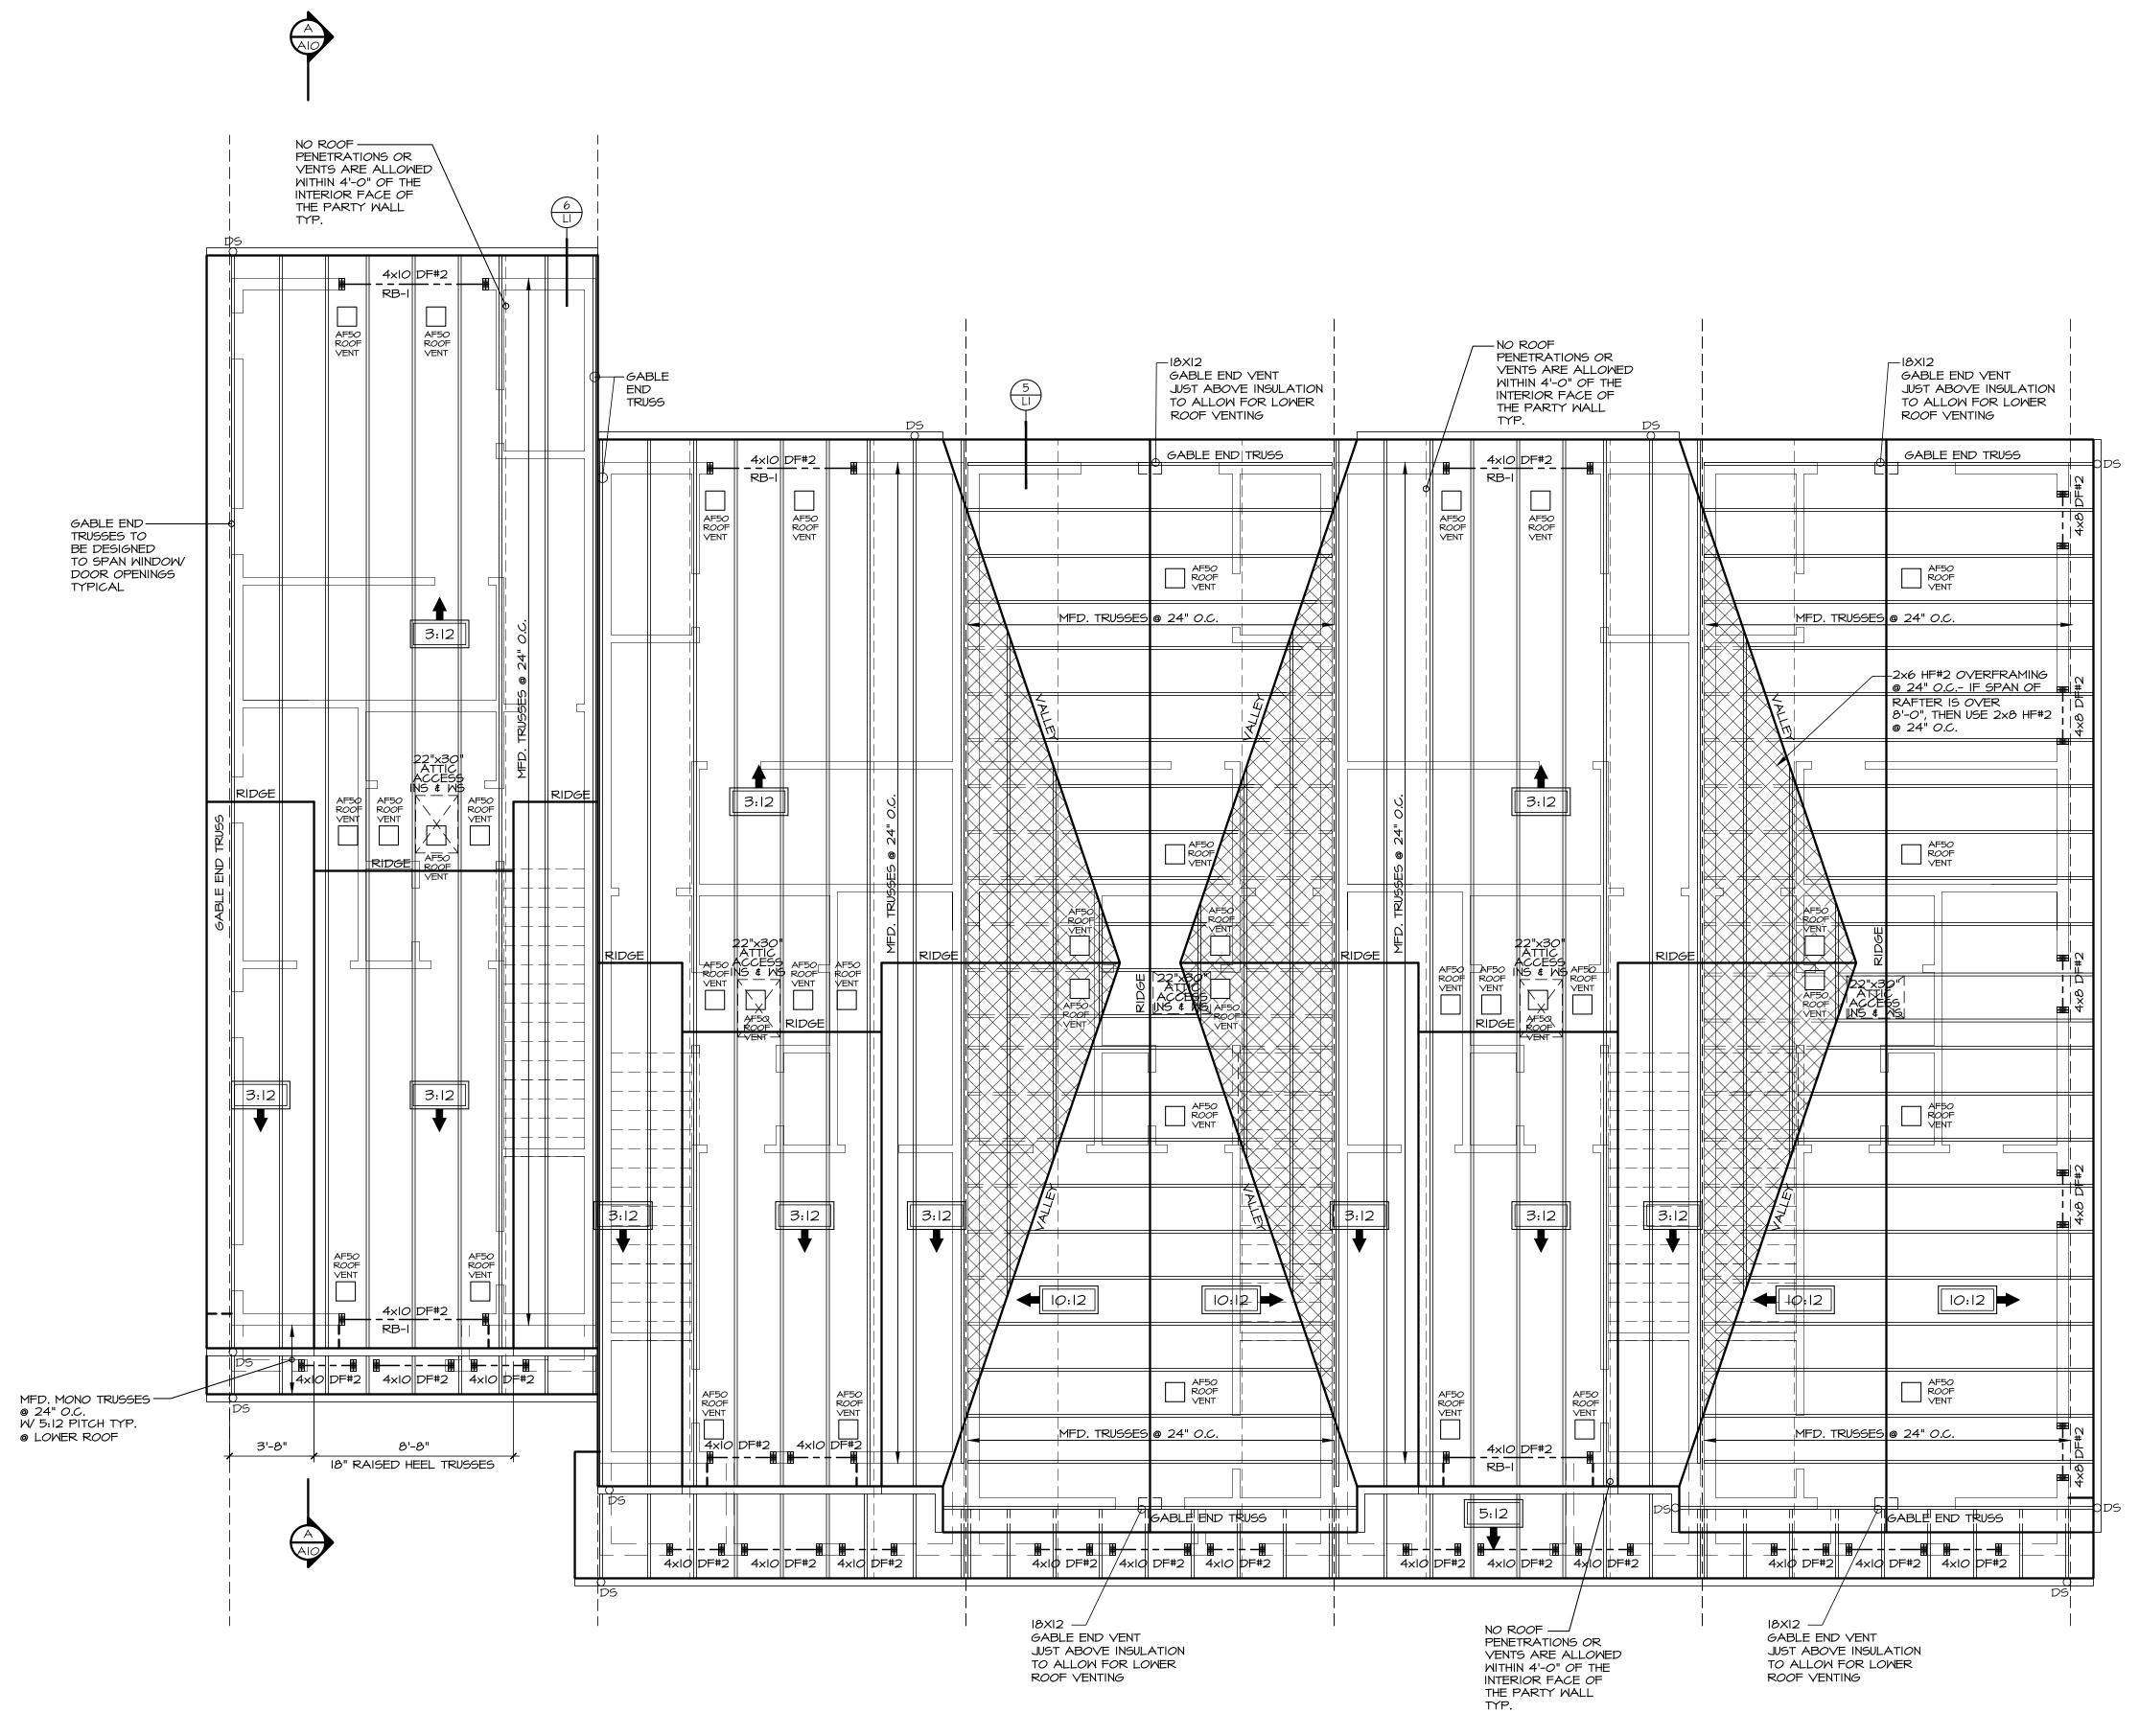

TRUSS NOTE

- ALL TRUSSES SHALL HAVE:

 I. STRESS ANALYSIS AND DRAWINGS /
 DETAILS STAMPED BY A STATE
 REGISTERED ENGINEER.
- MANUFACTURER'S STAMP ON PRE-MANUFACTURED TRUSSES.
- 3. BRACED TO MANUFACTURER'S SPECIFICATIONS.
- 4. STRESS ANALYSIS AND DETAILS
 SHALL BE SUBMITTED TO DESIGN
 PROFESSIONAL FOR APPROVAL AND SHALL
 BE KEPT ON SITE FOR FRAMING
 INSPECTION.
- TRUSSES WILL NOT BE FIELD ALTERED WITHOUT PRIOR BUILDING DEPARTMENT APPROVAL OR ENGINEERING CALCULATIONS.
- 6. ALL TRUSSES SHALL HAVE SIMPSON H-I CLIPS AT ENDS. WHERE TRUSSES ARE PARALLEL TO WALL, USE SIMPSON L3O AT MIDSPAN. USE SIMPSON STC CLIPS AT NON-BEARING WALLS


ROOF FRAMING NOTES

CUT RAFTER TAILS TO MATCH 2x4
TRUSSES

CONNECTORS SHALL BE ENGINEERED
BY TRUSS MANUFACTURER

ROOF PITCH SHALL BE 3:12
TYPICAL UNLESS NOTED OTHERWISE

ROOF OVERHANG SHALL BE 12" U.N.O.

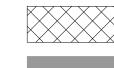

BEARING BELOW

DOWNSPOUT

2x6 OVERFRAMING

ROOF VENTING CALCULATION UNITS 1, 2 \$ 4

696 SQFT AREA = 2.32 SQFT REQUIRED

 $(2.32) \times (50\%)$ = 1.16 SQFT MIN. REQUIRED AT EAVES AF50 ROOF JACK VENTS @ EAVES = .34 SQFT EACH VENT PROVIDE 4 AF50 VENTS @ EAVES = 1.36 SQFT PROVIDED

(2.32) X (50%)= 1.16 SQFT MIN.
REQUIRED WITHIN 3' OF THE RIDGE
AF50 ROOF JACK VENTS= .34 SQFT EACH VENT
PROVIDE 4 AF50 VENTS= 1.36 SQFT PROVIDED

TOTAL VENT AREA PROVIDED= 2.72 SQ FT

ROOF VENTING CALCULATION UNITS 3 \$ 5

696 SQFT AREA = 2.32 SQFT REQUIRED

(2.32) X (50%)= 1.16 SQFT MIN. REQUIRED AT EAVES 18X12 GABLE VENTS= .75 SQFT EACH VENT PROVIDE (2) 18X12 VENT= 1.5 SQFT PROVIDED


(2.32) X (50%)= 1.16 SQFT MIN.
REQUIRED WITHIN 3' OF THE RIDGE
AF50 ROOF JACK VENTS= .34 SQFT EACH VENT
PROVIDE 4 AF50 VENTS= 1.36 SQFT PROVIDED

TOTAL VENT AREA PROVIDED= 2.86 SQ FT



SEE GENERAL NOTES

SCALE: 1/4" = 1'-0"

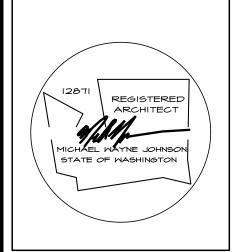

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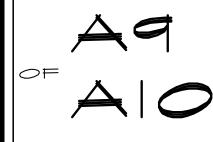
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YARDARM GROUP POPLAR POINT UNITS 1-5

date: 6-22-22 permit: revisions:

drawn by: LMD checked by: MMJ

SHEET



WRITTEN DIMENSIONS ON THIS DRAWING SHALL HAVE PRECEDENCE OVER SCALED DIMENSIONS. CONTRACTOR SHALL VERIFY ALL DIMENSIONS, CONDITIONS, ETC. PERTAINING TO THE WORK BEFORE PROCEEDING. THE OWNER MUST BE NOTIFIED OF ANY VARIATIONS FROM THE DIMENSIONS AND/OR CONDITIONS SHOWN ON THESE DRAWINGS. ANY SUCH VARIATION SHALL BE RESOLVED BY THE OWNER PRIOR TO PROCEEDING WITH THE WORK, OR THE CONTRACTOR SHALL ACCEPT FULL RESPONSIBILITY FOR THE COST TO RECTIFY SAME.

2018 WASHINGTON STATE ENERGY CODE

CLIMATE ZONE 5 AND MARINE 4


FENESTRATION U-FACTOR	SKYLIGHT U-FACTOR	GLAZED FENESTRATION SHGC		MOOD FRAMED MALL R-VALUE	FLOOR R-VALUE	BELOM GRADE MALL R-VALUE	SLAB R-VALUE AND DEPTH
0.28	0.50	NR	R-49 (R-38 VAULTED)	R-21	R-38	10/15 R-21 +TB	R-IO, 2 FEET


*TABLE 406.3- ENERGY CREDITS (SINGLE FAMILY)

THIS PLAN REQUIRES 6 CREDITS SINCE IT IS OVER 1500 SQUARE FEET AND UNDER 5000 SQUARE FEET

OPTION	_	CREDIT
HEATING OPTION 2	HEAT PUMP (ELECTRIC)	1.0
ENERGY OPTION 1.3	PRESCRIPTIVE COMPLIANCE IS BASED ON TABLE R402.I.I WITH THE FOLLOWING MODIFICATIONS: VERTICAL FENESTRATION U=0.28 FLOOR R-38 SLAB ON GRADE R-IO PERIMETER AND UNDER ENTIRE SLAB BELOW GRADE R-IO PERIMETER AND UNDER ENTIRE SLAB OR COMPLIANCE BASED ON SECTION R402.I.4: REDUCE THE TOTAL CONDUCTIVE UA BY 5%	.5
ENERGY OPTION 2.I	COMPLIANCE BASED ON R402.4.1.2: REDUCE THE TESTED AIR LEAKAGE TO 3.0 AIR CHANGES PER HOUR MAXIMUM 50 PASCALS AND ALL WHOLE HOUSE VENTILATION REQUIREMENTS AS DETERMINED BY SECTION MI507.3 OF THE INTERNATIONAL RESIDENTIAL CODE OR SECTION 408.3 OF THE INTERNATIONAL MECHANICAL CODE SHALL BE MET WITH A HIGH EFFICIENCY FAN(S) (MAXIMUM 0.35 watts/cfm), NOT INTERLOCKED WITH THE FURNACE FAN (IF PRESENT). VENTILATION SYSTEMS USING A FURNACE INCLUDING AN ECM MOTOR ARE ALLOWED, PROVIDED THAT THEY ARE CONTROLLED TO OPERATE AT A LOW SPEED IN VENTILATION ONLY MODE	1
ENERGY OPTION 3.6	DUCTLESS SPLIT SYSTEM HEAT PUMPS WITH NO ELECTRIC RESISTANCE HEATING IN THE PRIMARY LIVING AREAS. A DUCTLESS HEAT PUMP SYSTEM WITH A MINIMUM HSPF OF IO SHALL BE SIZED AND INSTALLED TO PROVIDE HEAT TO ENTIRE DWELLING UNIT AT THE DESIGN OUTDOOR AIR TEMPERATURE.	2.0
ENERGY OPTION 5.5	WATER HEATING SYSTEM SHALL INCLUDE THE FOLLOWING: ELECTRIC HEAT PUMP WATER HEATER MEETING THE STANDARDS FOR TIER III OF NEEA'S ADVANCED WATER HEATING SPECIFICATION	2.0

6.0 CREDITS

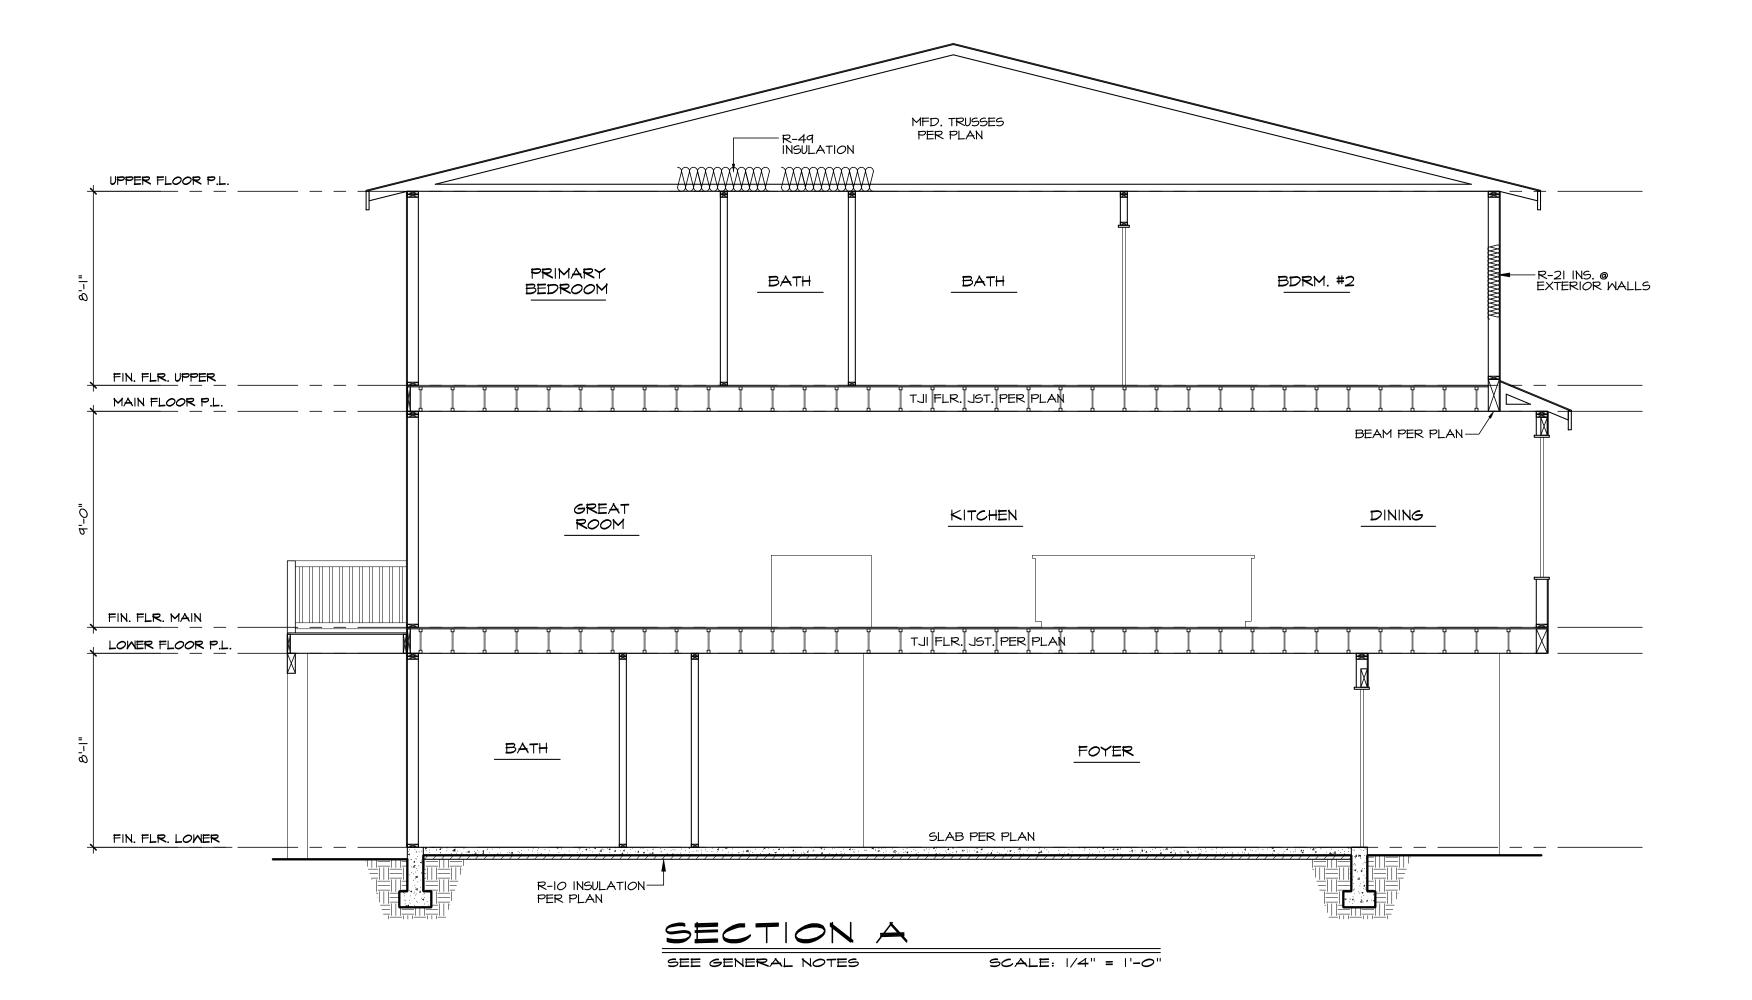

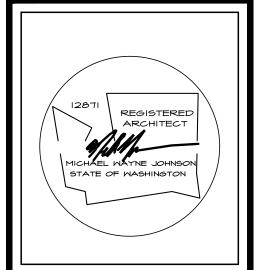

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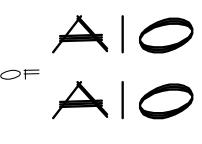
TOPLAR POINT UNITS I-5

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GA FILE NO. WP3370

Reference 20th edition Gypsum Association Fire Resistance Design Manual


FIRE RESISTANCE RATING: 1 HR LOAD-BEARING

SOUND TRANSMISSION RATING (STC): 45 to 49; test: Riverbank Acoustical Labs TL75-83


ASSEMBLY DESCRIPTION:

GYPSUM WALLBOARD, WOOD STUDS

One layer 5/8" type X gypsum wallboard or gypsum veneer base applied parallel or at right angles to each side of double row of 2 X 4 wood studs 16 "o.c. on separate plates 1" apart with 6d coated nails, 1-7/8" long, 0.0915" shank, 1/4" heads, 7" o.c. Joints staggered 16" each layer and side. Horizontal bracing required at mid-height. (LOAD-BEARING)

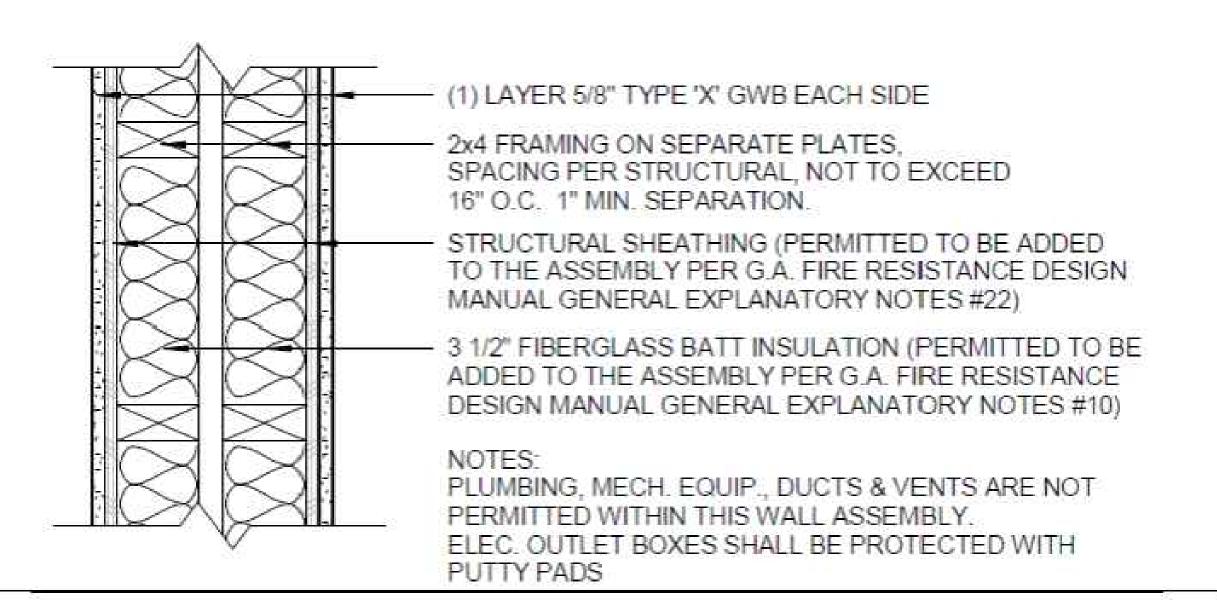



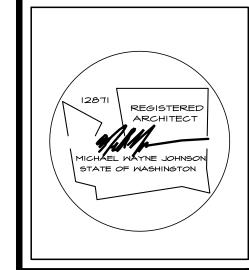



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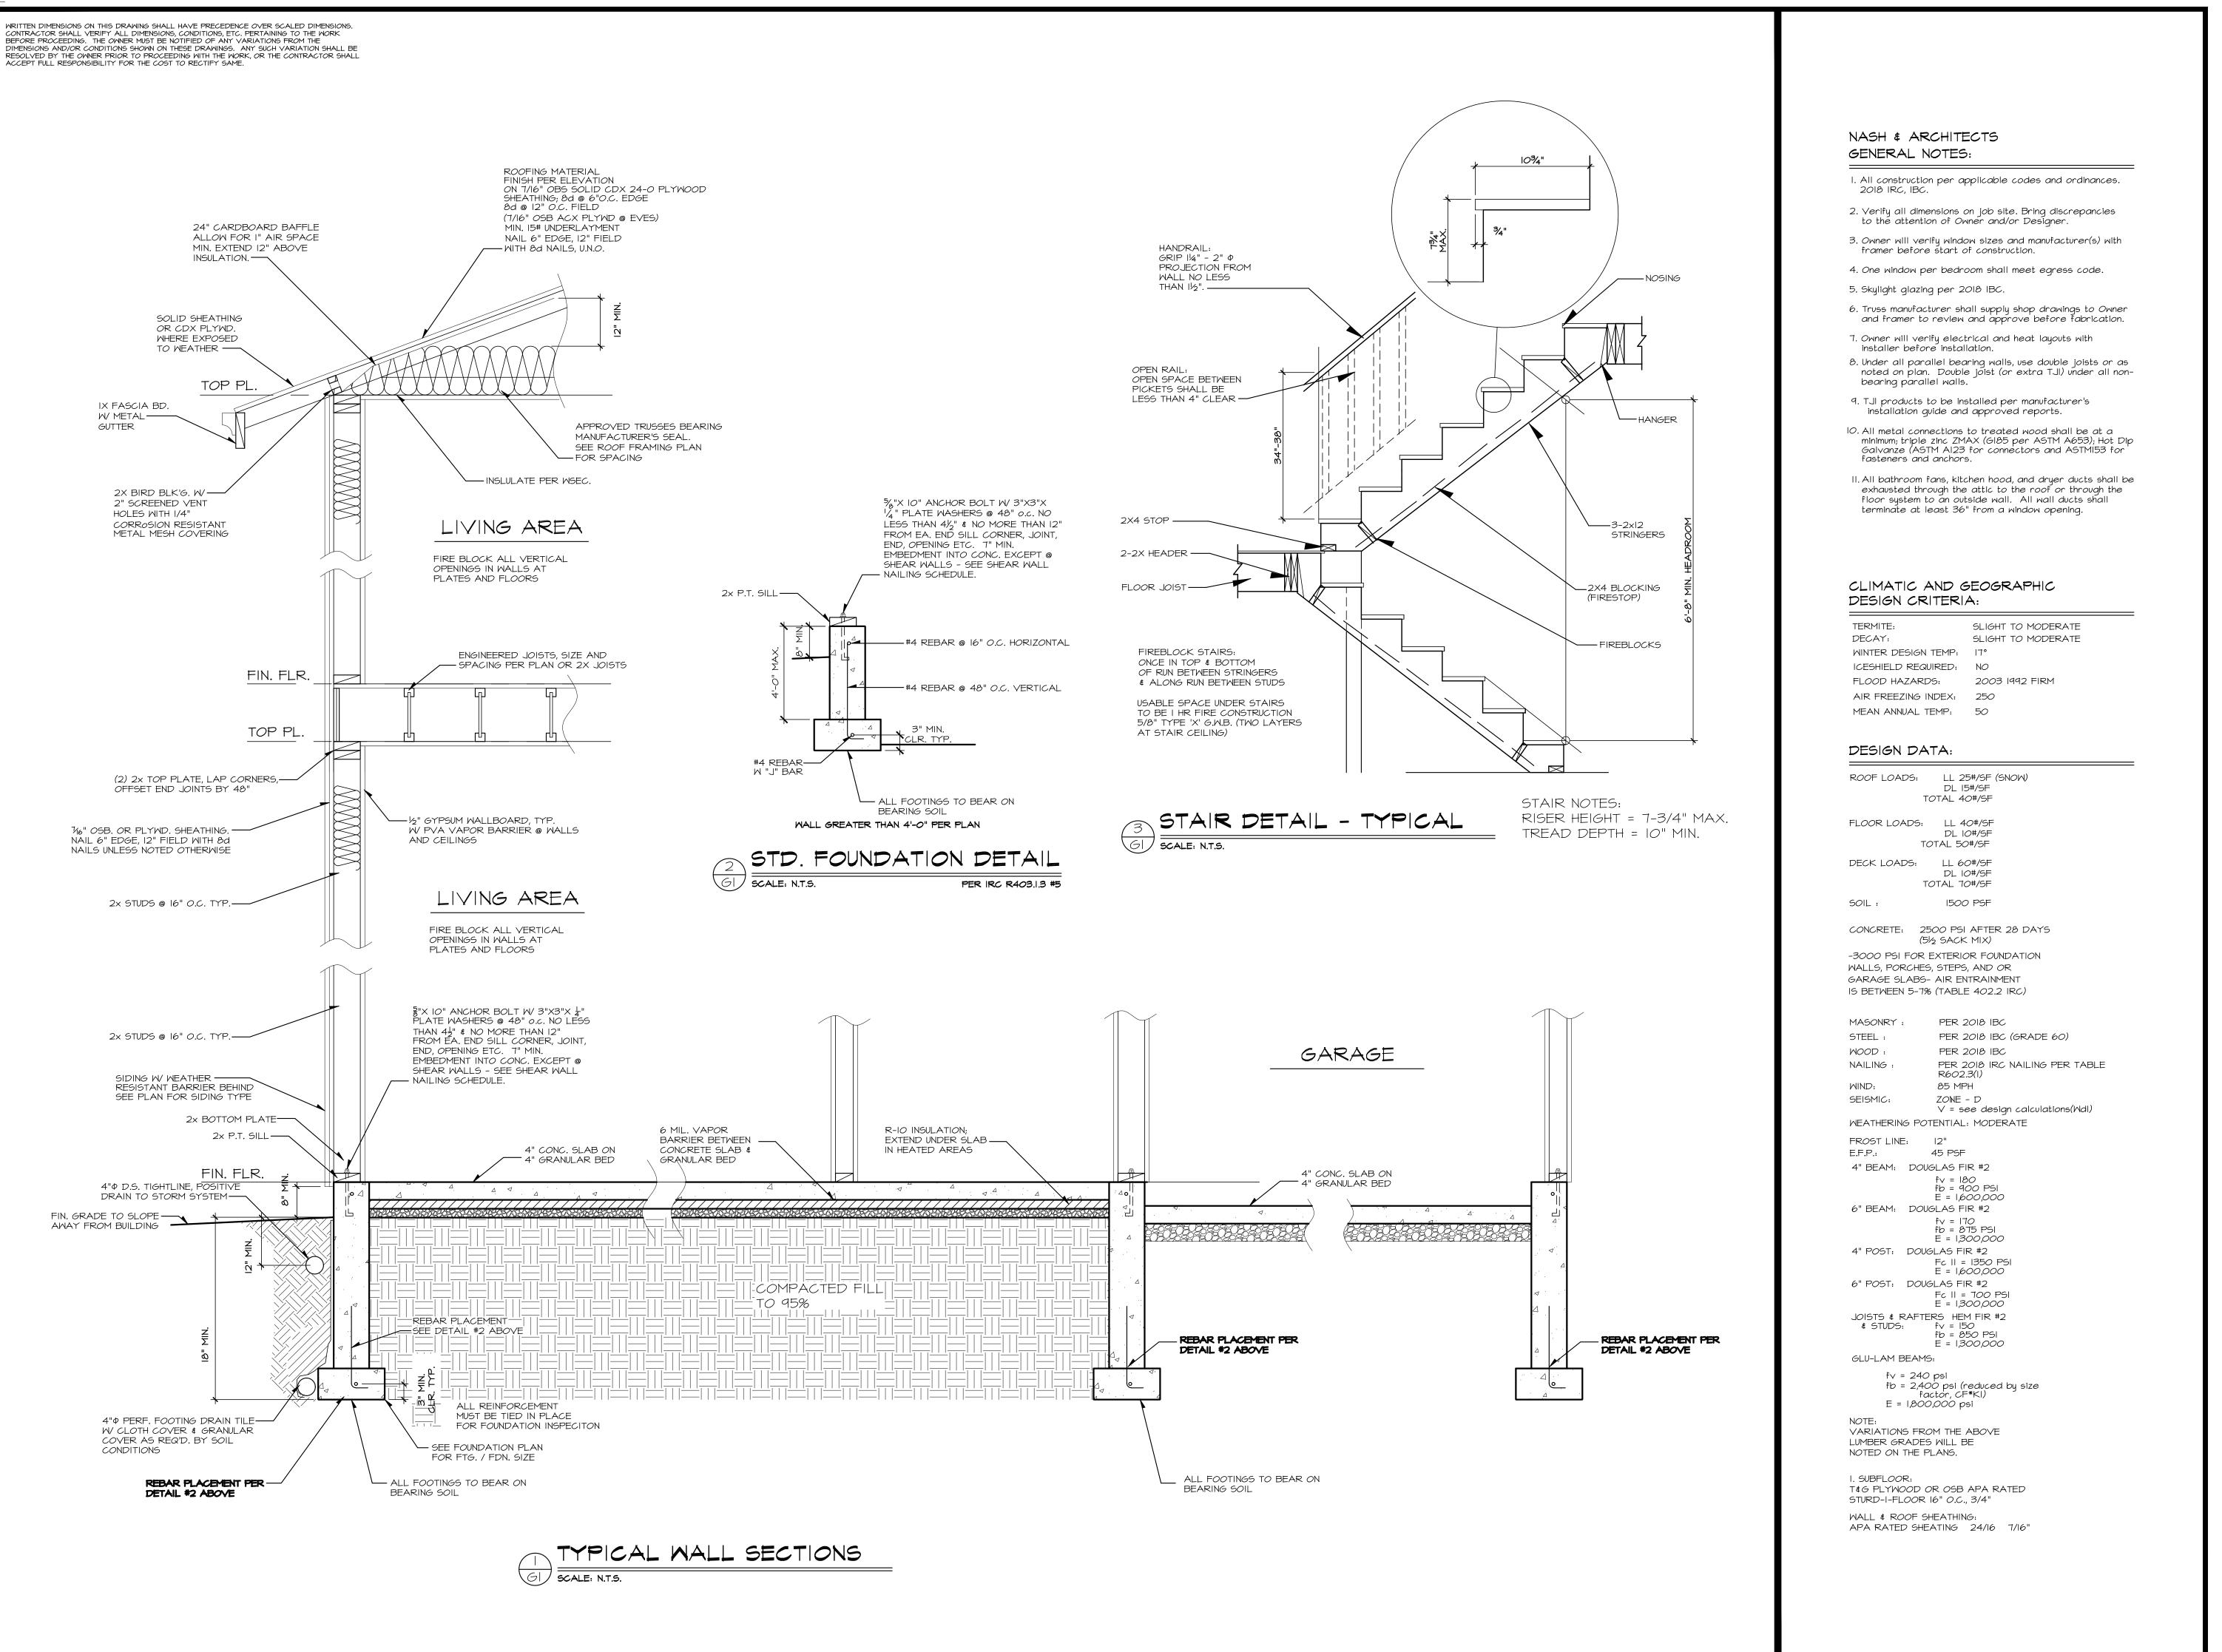
YARDARM GROUP POPLAR POINT UNITS 1-5


date: 6-22-22 permit: revisions:

drawn by: LMD checked by: MMJ



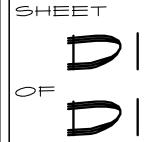

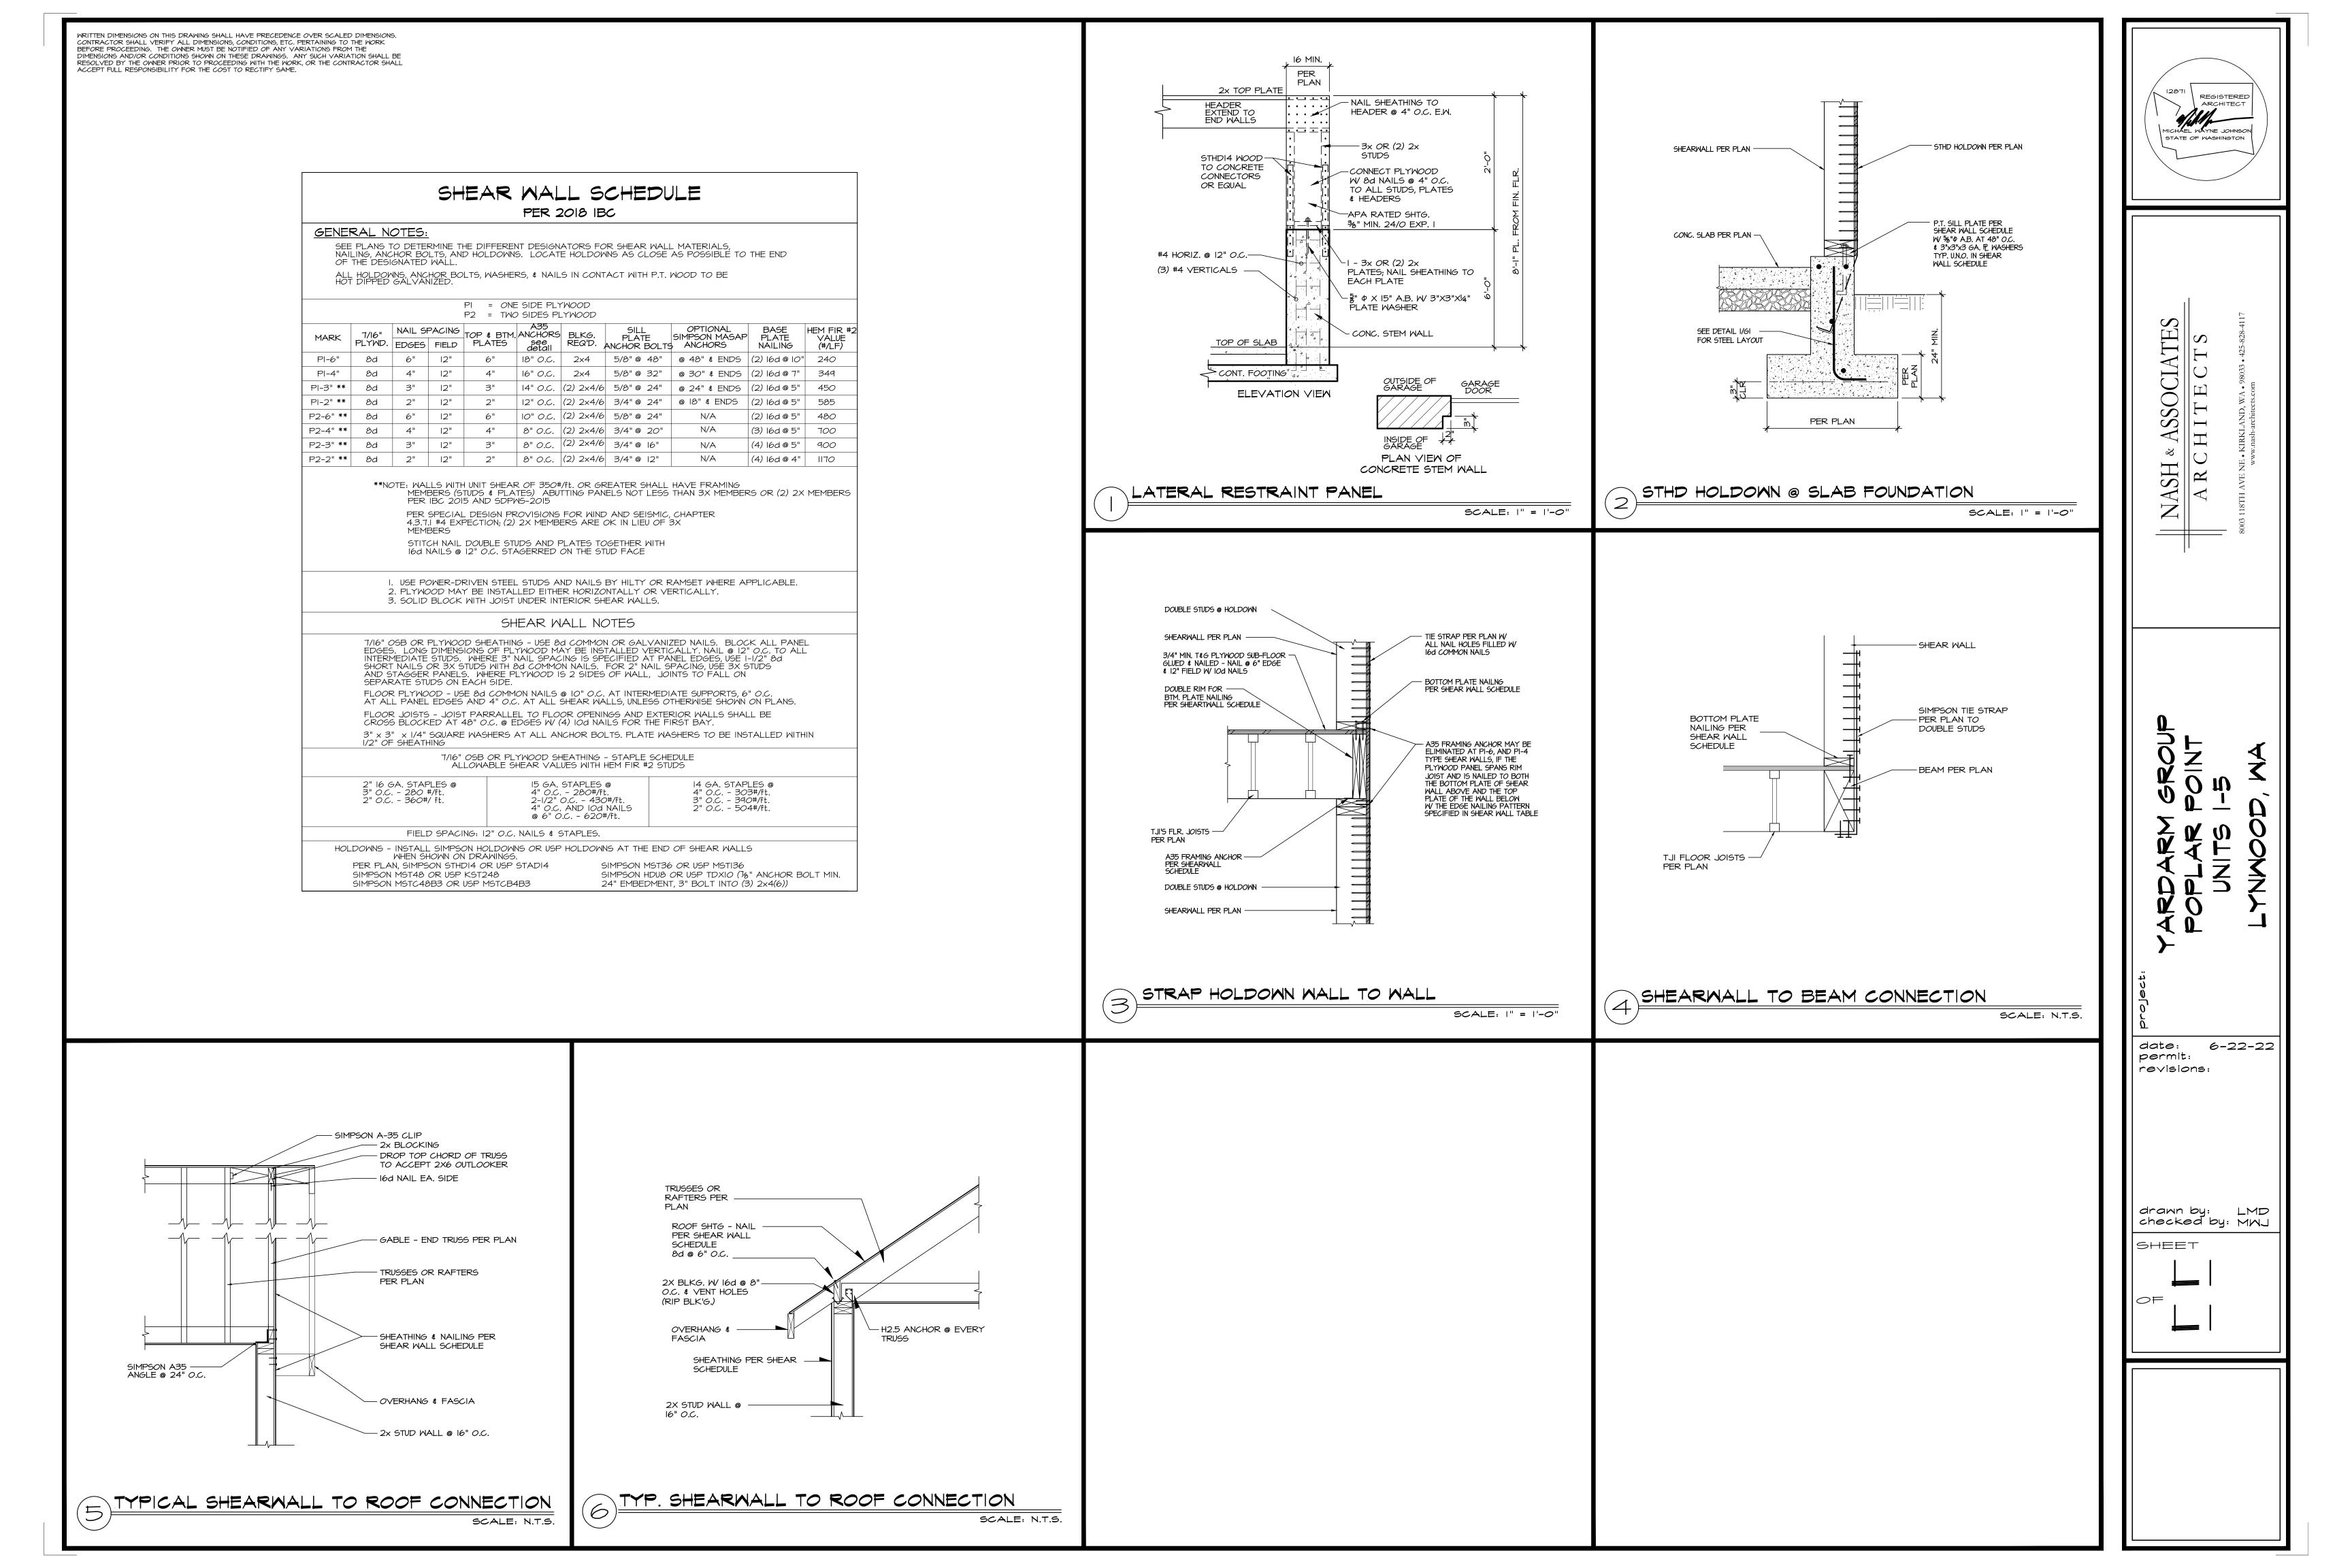

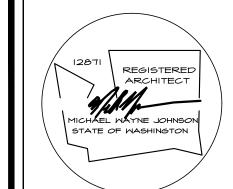

& ASSOCIATES
CHITECTS

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SF

TATIOAR OROUP POPLAR POINT PYPICAL MALL

date: 6-22-22 permit:

revisions:

drawn by: LMD checked by: MWJ

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